Appendix [A] Detailed Design Drawings		



KYOGLE COUNCIL

HW16 - BRUXNER HIGHWAY

MALLANGANEE RANGE TO WILLOCK STREET

SEGMENT 5390 TO 5400 37.52km TO 39.66kM WEST OF CASINO PAVEMENT REHABILITATION

ROAD DESIGN

DETAILED DESIGN

LOCALITY PLAN



PART INDEX

P	ART	CODE	NAME
		GE	GENERAL (4 SHEETS)
		RD	ROAD ALIGNMENT AND DETAIL (29 SHEETS)
	1	RC	ROAD CROSS SECTIONS (33 SHEETS)
		PV	PAVEMENT (10 SHEETS)
		RF	ROADSIDE FURNITURE, SIGNPOSTING AND PAVEMENT MARKING (10 SHEETS)

NOT FOR CONSTRUCTION

4/07/2022 6:27:30 AM C:\PROJECTS\16 BRUXNER HIGHWAY\N20 PREPARED BY DESIGNED VERIFIED TfNSW PROJECT MANAGER TRANSPORT FOR NSW INFRASTRUCTURE & PLACE **ENGINEERING SERVICES** NAME DYLAN TIGHT IAME DAVID JOHNSON NAME DAVID JOHNSON ACCORDANCE WITH THE BRIEF AND ROAD DESIGN NORTHERN ROAD DESIGNER PROJECT MANAGER / CLIENT

THIS PROJECT HAS BEEN DESIGNED IN REGIONAL & OUTER METROPOLITAN PROJECT MANAGEMENT NORTHERN

PROJECT MANAGER

KYOGLE COUNCIL HW16 - BRUXNER HIGHWAY MALLANGANEE RANGE TO WILLOCK STREET Transport 37.52km TO 39.66km FROM CASINO

DESIGN PROJECT No SF2019/160050 P.0067958.04.001.008.001 DS2020/000063

HW16 BRUXNER HIGHWAY - MALLANGANEE RANGE AND WILLOCK STREET S5390-5400 - INDEX

HEET NUMBER	SHEET DESCRIPTION
GE	GENERAL (4 SHEETS)
GE-0001	COVER SHEET
GE-0002	INDEX
GE-0003	KEY PLAN
GE-0004	GENERAL NOTES
RD	ROAD ALIGNMENT AND DETAIL (29 SHEETS)
RD-0001	ROAD ALIGNMENT PLAN - HW16 - BRUXNER HIGHWAY - MC00 - 37519 TO 37750
RD-0002	ROAD ALIGNMENT PLAN - HW16 - BRUXNER HIGHWAY - MC00 - 37750 TO 38000
RD-0003	ROAD ALIGNMENT PLAN - HW16 - BRUXNER HIGHWAY - MC00 - 38000 TO 38250
RD-0004	ROAD ALIGNMENT PLAN - HW16 - BRUXNER HIGHWAY - MC00 - 38250 TO 38500
RD-0005	ROAD ALIGNMENT PLAN - HW16 - BRUXNER HIGHWAY - MC00 - 38500 TO 38750
RD-0006	ROAD ALIGNMENT PLAN - HW16 - BRUXNER HIGHWAY - MC00 - 38750 TO 39000
RD-0007	ROAD ALIGNMENT PLAN - HW16 - BRUXNER HIGHWAY - MC00 - 39000 TO 39250
RD-0008	ROAD ALIGNMENT PLAN - HW16 - BRUXNER HIGHWAY - MC00 - 39250 TO 39500
RD-0009	ROAD ALIGNMENT PLAN - HW16 - BRUXNER HIGHWAY - MC00 - 39500 TO 39665
RD-0010	SURVEY AND ALLIGNMENT SHEDULE
RD-0011	TYPICAL CROSS-SECTIONS
RD-0012	DETAIL PLAN - HW16 - BRUXNER HIGHWAY - MC00 - 37519 TO 37750
RD-0013	DETAIL PLAN - HW16 - BRUXNER HIGHWAY - MC00 - 37750 TO 38000
RD-0014	DETAIL PLAN - HW16 - BRUXNER HIGHWAY - MC00 - 38000 TO 38250
RD-0015	DETAIL PLAN - HW16 - BRUXNER HIGHWAY - MC00 - 38250 TO 38500
RD-0016	DETAIL PLAN - HW16 - BRUXNER HIGHWAY - MC00 - 38500 TO 38750
RD-0017	DETAIL PLAN - HW16 - BRUXNER HIGHWAY - MC00 - 38750 TO 39000
RD-0018	DETAIL PLAN - HW16 - BRUXNER HIGHWAY - MC00 - 39000 TO 39250
RD-0019	DETAIL PLAN - HW16 - BRUXNER HIGHWAY - MC00 - 39250 TO 39500
RD-0020	DETAIL PLAN - HW16 - BRUXNER HIGHWAY - MC00 - 39500 TO 39665
RD-0021	LONGITUDINAL SECTION - HW16 - BRUXNER HIGHWAY - MC00 - 37519TO 37750
RD-0022	LONGITUDINAL SECTION - HW16 - BRUXNER HIGHWAY - MC00 - 37750 TO 38000
RD-0023	LONGITUDINAL SECTION - HW16 - BRUXNER HIGHWAY - MC00 - 38000 TO 38250
RD-0024	LONGITUDINAL SECTION - HW16 - BRUXNER HIGHWAY - MC00 - 38250 TO 38500
RD-0025	LONGITUDINAL SECTION - HW16 - BRUXNER HIGHWAY - MC00 - 38500 TO 38750
RD-0026	LONGITUDINAL SECTION - HW16 - BRUXNER HIGHWAY - MC00 - 38750 TO 39000
RD-0027	LONGITUDINAL SECTION - HW16 - BRUXNER HIGHWAY - MC00 - 39000 TO 39250
RD-0028	LONGITUDINAL SECTION - HW16 - BRUXNER HIGHWAY - MC00 - 39250 TO 39500
RD-0029	LONGITUDINAL SECTION - HW16 - BRUXNER HIGHWAY - MC00 - 39500TO 39665
RC	ROAD CROSS SECTIONS (33 SHEETS)
RC-0001	CROSS SECTION HW16 - BRUXNER HIGHWAY - MC00 - 37 519 TO 37 575
RC-0002	CROSS SECTION HW16 - BRUXNER HIGHWAY - MC00 - 37 600 TO 37 675
RC-0003	CROSS SECTION HW16 - BRUXNER HIGHWAY - MC00 - 37 700 TO 37 775
RC-0004	CROSS SECTION HW16 - BRUXNER HIGHWAY - MC00 - 37 800 TO 37 875
RC-0005	CROSS SECTION HW16 - BRUXNER HIGHWAY - MC00 - 37 900 TO 37 975
RC-0006	CROSS SECTION HW16 - BRUXNER HIGHWAY - MC00 - 38 000 TO 38 025
RC-0007	CROSS SECTION HW16 - BRUXNER HIGHWAY - MC00 - 38 050 TO 38 075
RC-0008	CROSS SECTION HW16 - BRUXNER HIGHWAY - MC00 - 38 100 TO 38 125
RC-0009	CROSS SECTION HW16 - BRUXNER HIGHWAY - MC00 - 38 150 TO 38 200
RC-0010	CROSS SECTION HW16 - BRUXNER HIGHWAY - MC00 - 38 225 TO 38 250

SHEET NUMBER	SHEET DESCRIPTION
RC-0011	CROSS SECTION HW16 - BRUXNER HIGHWAY - MC00 - 38 275 TO 38 300
RC-0012	CROSS SECTION HW16 - BRUXNER HIGHWAY - MC00 - 38 325 TO 38 350
RC-0013	CROSS SECTION HW16 - BRUXNER HIGHWAY - MC00 - 38 375 TO 38 400
RC-0014	CROSS SECTION HW16 - BRUXNER HIGHWAY - MC00 - 38 425 TO 38 500
RC-0015	CROSS SECTION HW16 - BRUXNER HIGHWAY - MC00 - 38 525
RC-0016	CROSS SECTION HW16 - BRUXNER HIGHWAY - MC00 - 38 550 TO 38 575
RC-0017	CROSS SECTION HW16 - BRUXNER HIGHWAY - MC00 - 38 600 TO 38 625
RC-0018	CROSS SECTION HW16 - BRUXNER HIGHWAY - MC00 - 38 650 TO 38 675
RC-0019	CROSS SECTION HW16 - BRUXNER HIGHWAY - MC00 - 38 700
RC-0020	CROSS SECTION HW16 - BRUXNER HIGHWAY - MC00 - 38 725
RC-0021	CROSS SECTION HW16 - BRUXNER HIGHWAY - MC00 - 38 750 TO 38 775
RC-0022	CROSS SECTION HW16 - BRUXNER HIGHWAY - MC00 - 38 800 TO 38 825
RC-0023	CROSS SECTION HW16 - BRUXNER HIGHWAY - MC00 - 38 850 TO 38 875
RC-0024	CROSS SECTION HW16 - BRUXNER HIGHWAY - MC00 - 38 900 TO 38 925
RC-0025	CROSS SECTION HW16 - BRUXNER HIGHWAY - MC00 - 38 950 TO 38 975
RC-0026	CROSS SECTION HW16 - BRUXNER HIGHWAY - MC00 - 39 000 TO 39 075
RC-0027	CROSS SECTION HW16 - BRUXNER HIGHWAY - MC00 - 39 100 TO 39 175
RC-0028	CROSS SECTION HW16 - BRUXNER HIGHWAY - MC00 - 39 200 TO 39 275
RC-0029	CROSS SECTION HW16 - BRUXNER HIGHWAY - MC00 - 39 300 TO 39 375
RC-0030	CROSS SECTION HW16 - BRUXNER HIGHWAY - MC00 - 39 400 TO 39 475
RC-0031	CROSS SECTION HW16 - BRUXNER HIGHWAY - MC00 - 39 500 TO 39 550
RC-0032	CROSS SECTION HW16 - BRUXNER HIGHWAY - MC00 - 39 575 TO 39 650
RC-0033	CROSS SECTION HW16 - BRUXNER HIGHWAY - MC00 - 39 665
PV	PAVEMENT (10 SHEETS)
PV-0001	PAVEMENT PROFILES
PV-0002	PAVEMENT PLAN - HW16 BRUXNER HIGHWAY - MC00 - 37520 TO 37750
PV-0003	PAVEMENT PLAN - HW16 BRUXNER HIGHWAY - MC00 - 37750 TO 38000
PV-0004	PAVEMENT PLAN - HW16 BRUXNER HIGHWAY - MC00 - 38000 TO 38250
PV-0005	PAVEMENT PLAN - HW16 BRUXNER HIGHWAY - MC00 - 38250 TO 38500
PV-0006	PAVEMENT PLAN - HW16 BRUXNER HIGHWAY - MC00 - 38500 TO 38750
PV-0007	PAVEMENT PLAN - HW16 BRUXNER HIGHWAY - MC00 - 38750 TO 39000
PV-0008	PAVEMENT PLAN - HW16 BRUXNER HIGHWAY - MC00 - 39000 TO 39250
PV-0009	PAVEMENT PLAN - HW16 BRUXNER HIGHWAY - MC00 - 39250 TO 39500
PV-0010	PAVEMENT PLAN - HW16 BRUXNER HIGHWAY - MC00 - 39500 TO 39665
RF	ROADSIDE FURNITURE, SIGNPOSTING AND PAVEMENT MARKING (10 SHEETS)
RF-0001	ROAD FURNITURE AND LINEMARKING SCHEDULES
RF-0002	ROADSIDE FURNITURE PLAN - HW16 BRUXNER HIGHWAY - MC00 - 37519 TO 37750
RF-0003	ROADSIDE FURNITURE PLAN - HW16 BRUXNER HIGHWAY - MC00 - 37750 TO 38000
RF-0004	ROADSIDE FURNITURE PLAN - HW16 BRUXNER HIGHWAY - MC00 - 38000 TO 38250
RF-0005	ROADSIDE FURNITURE PLAN - HW16 BRUXNER HIGHWAY - MC00 - 38250 TO 38500
RF-0006	ROADSIDE FURNITURE PLAN - HW16 BRUXNER HIGHWAY - MC00 - 38500 TO 38750
RF-0007	ROADSIDE FURNITURE PLAN - HW16 BRUXNER HIGHWAY - MC00 - 38750 TO 39000
RF-0008	ROADSIDE FURNITURE PLAN - HW16 BRUXNER HIGHWAY - MC00 - 39000 TO 39250
RF-0009	ROADSIDE FURNITURE PLAN - HW16 BRUXNER HIGHWAY - MC00 - 39250 TO 39500
RF-0010	ROADSIDE FURNITURE PLAN - HW16 BRUXNER HIGHWAY - MC00 - 39500 TO 39665

NOT FOR CONSTRUCTION

Transport

KYOGLE COUNCIL
HW16 - BRUXNER HIGHWAY
MALLANGANEE RANGE - WILLOCK STREET S5390-5400
37.52km TO 39.66km FROM CASINO DESIGN MODEL FILE(S) USED FOR DOCUMENTATION OF THIS DRAWING HW16_MallanganeeRangeWillock_Design_IFC_V1.txt PLOT BY tightd 7/03/2022 12:04:12 PM N2019070 K:\PROJECTS\16_BRUXNER HIGHWAY\N2019070 Mallanganee Range and W≣ock st S5390_S5400\DRAWINGS\Final\DS2020-000063-01-GE.dgn EXTERNAL REFERENCE FILES REV DATE AMENDMENT / REVISION DESCRIPTION WVR No. | APPROVAL | SCALES ON A3 SIZE DRAWING DRAWINGS / DESIGN PREPARED BY TITLE D. TIGHT TRANSPORT FOR NSW DRAWN NSW GOVERNMENT INFRASTRUCTURE & PLACE DRG CHECK D.JOHNSON INDEX for NSW ENGINEERING SERVICES D. TIGHT DESIGN ROAD DESIGN NORTHERN TfNSW REGISTRATION No. DS2020/000063 DESIGN CHECK D.JOHNSON REGIONAL MAINTENANCE
REGIONAL MAINTENANCE DELIVERY NORTHERN ISSUE STATUS
PROJECT MANAGEMENT NORTHERN DETAIL DES D.JOHNSON DESIGN MANAGER CO-ORDINATE SYSTEM MGA ZONE 56 HEIGHT DATUM AHD GE-0002 PROJECT MANAGER R. GERSERKOWSKI DETAIL DESIGN

| 20 | 25 | 30 | 35 | 40 | 45 | 50mm ON A3 SIZE ORIGINAL

GENERAL NOTES

- THESE NOTES SHOULD BE READ IN CONJUNCTION WITH OTHER ENGINEERING DRAWINGS, SPECIFICATIONS AND WRITTEN INSTRUCTIONS. ALWAYS REFER TO TECHNICAL SPECIFICATIONS FOR CLARIFICATION AND DETAILS.
- ALL CONSTRUCTION MATERIALS AND WORKMANSHIP SHALL BE IN ACCORDANCE WITH THE RELEVANT SPECIFICATION FOR THE WORKS TOGETHER WITH THE REQUIREMENTS OF ALL RELEVANT CODES OF PRACTICE REFERRED TO THEREIN AND THE REQUIREMENTS OF ALL STATUTORY AUTHORITIES.
- LEVELS AND CONTOURS ARE IN METRES (m) AND DIMENSIONS ARE IN MILLIMETERS (mm) UNLESS NOTED OTHERWISE (UNO). SCALES AND SCALE BARS ARE FOR A3 SIZE DRAWINGS
- ALL LEVELS ARE TO AHD DATUM.
- ALL COORDINATES ARE AS PER CO-ORDINATE SYSTEM STATED IN TITLE BLOCK. 5.
- ALL STATIONS AND RADII ARE IN METRES.
- ALL LOCATIONS, ORIENTATION AND LEVELS SHALL BE VERIFIED ON SITE BEFORE COMMENCING ANY WORK, REFER DISCREPANCIES TO THE PRINCIPAL, DO NOT OBTAIN DIMENSIONS FROM SCALING.
- THE CONTRACTOR SHALL ENSURE ACCESS IS AVAILABLE TO PROPERTIES AT ALL TIMES DURING CONSTRUCTION.
- THESE DRAWINGS ARE BASED ON GROUND FEATURES AS AT THE DATE OF SURVEY 28/09/2019

UTILITIES

- THE UTILITY INFORMATION SHOWN IN THE DRAWINGS IS SCHEMATIC ONLY AND IS INTENDED TO ACCENTUATE THE PRESENCE OF PUBLIC UTILITY SERVICES ALONG THE PROJECT LENGTH ACTUAL LOCATIONS SHOULD BE VERIFIED PRIOR TO CONSTRUCTION.
- IN ORDER TO AVOID DAMAGE TO THE SERVICES THE CONTRACTOR SHALL BE RESPONSIBLE FOR CO-ORDINATING THE WORKS ADJACENT TO ANY SERVICE WITH THE RELEVANT UTILITY AUTHORITY IN ACCORDANCE WITH THE AUTHORITY REQUIREMENTS.
- THE CONTRACTOR SHALL CO-ORDINATE WITH THE RELEVANT UTILITY AUTHORITIES AND THE PRINCIPAL WITH RESPECT TO ANY TEMPORARY DIVERSIONS NECESSARY FOR CONSTRUCTION

LANDSCAPING

ALL DISTURBED AREAS TO BE STABILISED WITH 100mm TOPSOIL LAYER AND HAND SEEDED. REFER TO SPECIFICATION R178 FOR DETAILS.

PAVEMENT MARKING, ROAD FURNITURE & SIGN POSTING

- THESE DRAWINGS ARE TO BE READ IN CONJUNCTION WITH THE SPECIFICATION
- REFER TO R.M.S. STANDARD DRAWINGS FOR SAFETY BARRIER DETAILS. UNLESS SPECIFIED OTHERWISE.
- FOR DETAILS OF SAFETY BARRIER DELINEATORS REFER R.M.S. STANDARD DRG OR
- SIGN POSTS PLACED WITHIN THE CLEAR ZONE WITHOUT SAFETY BARRIER PROTECTION SHALL BE FRANGIBLE.
- FOR DETAILS OF PAVEMENT MARKINGS, SIGN POSTS AND SIGN SUPPORT STRUCTURES REFER R.M.S. GUIDELINES. STANDARD DRGS. RELEVANT AUSTRALIAN SPECIFICATION AND DRG'S BY OTHERS
- ALL PERMANENT PAVEMENT MARKINGS SHALL BE IN WATERBORNE PAINT UNLESS NOTED OTHERWISE.
- GUIDE POST / DELINEATOR SPACING IS 60m UNO.

STORMWATER DRAINAGE

- THE DOCUMENTED DRAINAGE SYSTEM IS DETAILED ONLY FOR NORMAL AUSTROADS TRAFFIC LOADING CONSTRUCTION VEHICLE REQUIREMENTS SHALL BE THE CONTRACTOR'S RESPONSIBILITY.
- UNSUITABLE FOUNDING MATERIAL FOR PIPES AND STRUCTURES SHALL BE REMOVED OR IMPROVED IN ACCORDANCE WITH THE RELEVANT SPECIFICATIONS AND TO THE PRINCIPAL'S SATISFACTION
- REINFORCEMENT EXPOSED IN MODIFICATION OF PRECAST COMPONENTS SHALL BE PROTECTED WITH THE APPROVED METHOD OF COVER REPLACEMENT TO THE PRINCIPAL'S SATISFACTION.
- WHERE NOTED ON THE PLANS BATTERS ARE TO BE RECONTOURED AROUND DRAINAGE LINES
- EXISTING DRAINAGE CULVERTS DEPICTED AS REMAINING MUST BE CHECKED BY THE CONTRACTOR FOR CONDITION. THE CONTRACTOR IS TO UNDERTAKE A CONDITION SURVEY. FOR DETAILS OF GUARDFENCE, HEADWALLS AND SO KERB REFER TO MODEL DRAWINGS.

SAFETY BARRIERS

- BARRIER TO BE INSTALLED AS PER RMS MODEL DRAWINGS LISTED IN THE SUPPLEMENTARY DRAWING INDEX, OR TO MANUFACTURES SPECIFICATIONS.
- ANY CHANGES TO PRODUCTS LISTED IN THE BARRIER SCHEDULES ARE TO BE MADE IN CONSULTATION WITH THE DESIGNER

SUPPLEMENTARY DRAWING INDEX

DRAWING NUMBER	DESCRIPTION OF DRAWING
R0100-01	ROCK FILLED MATTRESS PROTECTION FO CULVERTS AT INLETS AND OUTLETS
R0230	STORMWATER DRAINAGE SERIES - BATTER DRAINS
R0220-22	STORMWATER DRAINAGE SERIES - GULLY PITS - STANDARDS GULLY PIT SO2
R0240-01	STORMWATER DRAINAGE SERIES - PIPES - INSTALLATION OF BURIED CONCRETE PIPES
R0300-01	STANDARD KERB AND CHANNEL SHAPES
R0710-04	W-BEAM AND THRIE BEAM SAFETY BARRIERS POST ON SLIP BASE
R0710-09	W-BEAM AND THRIE BEAM SAFETY BARRIERS W-BEAM TO THRIE BEAM TRANSITION
R0710-15	W-BEAM/THRIE BEAM RAIL FASTENER COMPONENTS M16 BOLTS AND NUTS - RAIL
R0710-16	W-BEAM/THRIE BEAM RAIL FASTENER COMPONENTS HEXAGON HEAD BOLTS AND NUTS
R0710-17	W-BEAM/THRIE BEAM POST AND SLIP BASE HEXAGON HEAD BOLTS AND NUTS
R0710-18	W-BEAM AND THRIE BEAM SAFETY BARRIER DELINEATION UNIT
R0710-19	AASHTO G4 W BEAM ASSEMBLY
MD.R33.A04	STANDARD PAVEMENT SUBSURFACE DRAINAGE DETAILS - BATTER OUTLET FOR SUBSURFACE DRAINS
MD.R37.A01	STANDARD PAVEMENT SUBSURFACE DRAINAGE DETAILS - INTRA PAVEMENT DRAINS


NOT FOR CONSTRUCTION

DESIGN MODEL FILE(S) USED FOR DOCUMENTATION OF THIS DRAWING :.PROJECTS\16_BRUXNER HIGHWAY\N2019070 Mallanganee Range and W∎ock st S5390_S5400\DRAWINGS\FinalIDS2020-000063-01-GE.dgr N2019070 HW16_MallanganeeRangeWillock_Design_IFC_V1.txt 4/07/2022 6:27:30 AM tightd AMENDMENT / REVISION DESCRIPTION DRAWINGS / DESIGN PREPARED BY EXTERNAL REFERENCE FILES SCALES ON A3 SIZE DRAWING REV DATE WVR No. APPROVAL TITLE D TIGHT TRANSPORT FOR NSW DRAWN INFRASTRUCTURE & PLACE ORG CHECK D.JOHNSON ENGINEERING SERVICES DESIGN D. TIGHT ROAD DESIGN NORTHERN DESIGN CHECK D.JOHNSON REGIONAL MAINTENANCE DESIGN MANAGER D.JOHNSON CO-ORDINATE SYSTEM HEIGHT DATUM REGIONAL MAINTENANCE DELIVERY NORTHERN ISSUE STATUS R. GERSERKOWSKI PROJECT MANAGEMENT NORTHERN MGA ZONE 56 AHD PROJECT MANAGER


KYOGI E COUNCII HW16 - BRUXNER HIGHWAY

MALLANGANEE RANGE - WILLOCK STREET S5390-5400 Transport 37.52km TO 39.66km FROM CASINO **GENERAL NOTES** for NSW

TNSW REGISTRATION No. DS2020/000063 GE-0004 QA4331765 DETAIL DESIGN

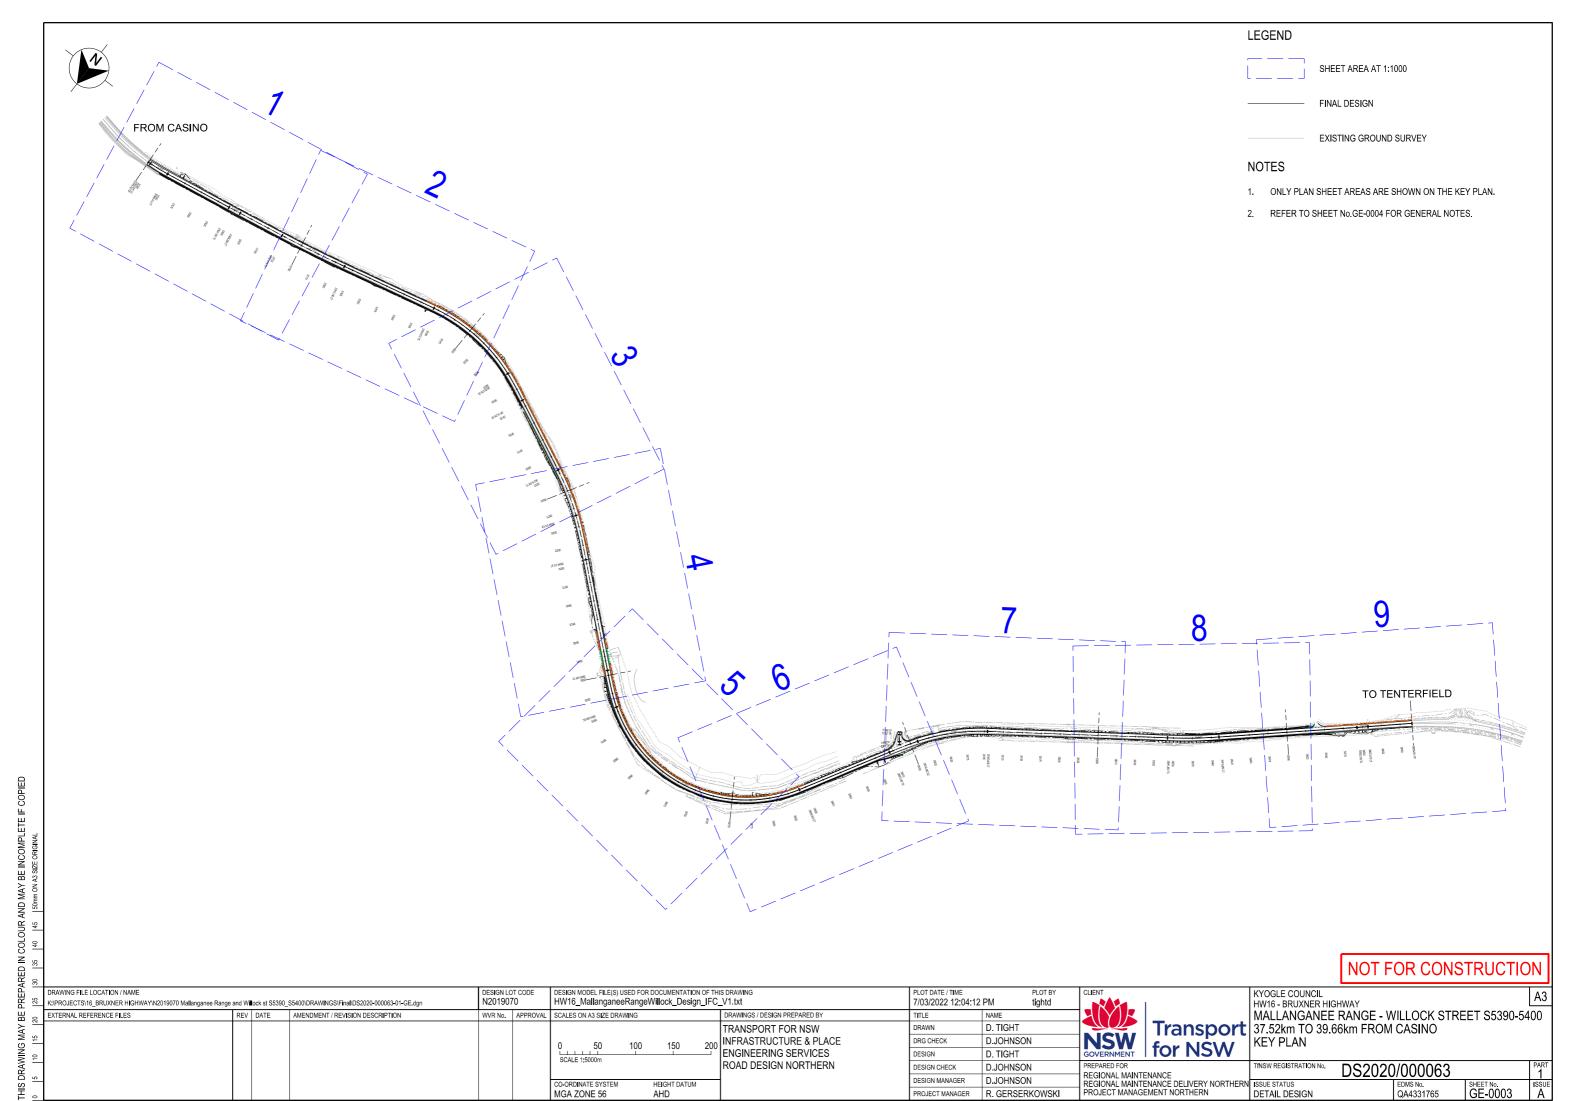

Transport for NSM

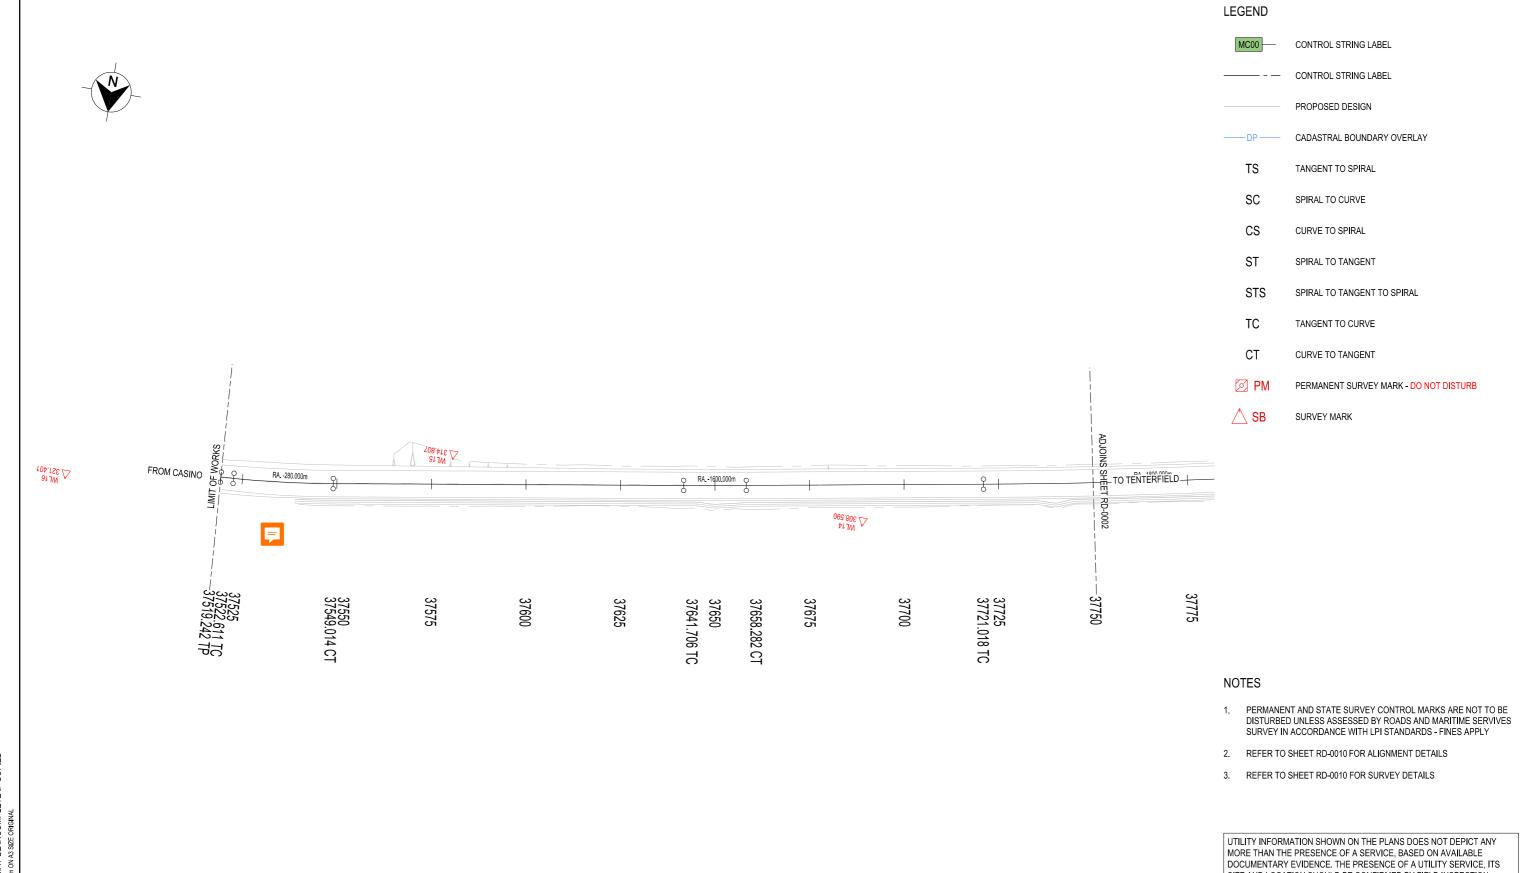

DRAWINGS / DESIGN PREPARED BY

TRANSPORT FOR NSW

40 INFRASTRUCTURE & PLACE

ENGINEERING SERVICES

ROAD DESIGN NORTHERN

DESIGN MODEL FILE(S) USED FOR DOCUMENTATION OF THIS DRAWING

30

HEIGHT DATUM

HW16_MallanganeeRangeWillock_Design_IFC_V1.txt

SCALES ON A3 SIZE DRAWING

CO-ORDINATE SYSTEM

MGA ZONE 56

N2019070

WVR No. APPROVAL

⟨:\PROJECTS\16_BRUXNER HIGHWAY\N2019070 Mallanganee Range and W≣ock st \$5390_\$5400\DRAWINGS\Final\D\$2020-000063-02-RA.dgn

EXTERNAL REFERENCE FILES

REV DATE AMENDMENT / REVISION DESCRIPTION

SIZE AND LOCATION SHOULD BE CONFIRMED BY FIELD INSPECTION, PRIOR TO THE COMMENCEMENT OF ROADWORKS AND THE RELEVANT UTILITY PLANS OBTAINED BY DIALLING PH 1100 OR FAX 1300 652 077 (DIAL BEFORE YOU DIG). CAUTION SHOULD BE EXERCISED WHEN WORKING IN THE VICINITY OF ALL UTILITY SERVICES.

NOT FOR CONSTRUCTION

KYOGLE COUNCIL HW16 - BRUXNER HIGHWAY

for NSW

REGIONAL MAINTENANCE
REGIONAL MAINTENANCE DELIVERY NORTHERN ISSUE STATUS
PROJECT MANAGEMENT NORTHERN DETAIL DES

11/07/2022 1:11:53 PM

TITLE

DRAWN

DESIGN

DRG CHECK

DESIGN MANAGER

tightd

D. TIGHT

D. TIGHT

PROJECT MANAGER R. GERSERKOWSKI

D.JOHNSON

D.JOHNSON


D.JOHNSON

ROAD ALIGNMENT PLAN HW16 - BRUXNER HIGHWAY - MC00 - 37519 TO 37750

Transport MALLANGANEE RANGE - WILLOCK STREET S5390-5400 37.52km TO 39.66km FROM CASINO

TfNSW REGISTRATION No.

DS2020/000063 RD-0001 DETAIL DESIGN

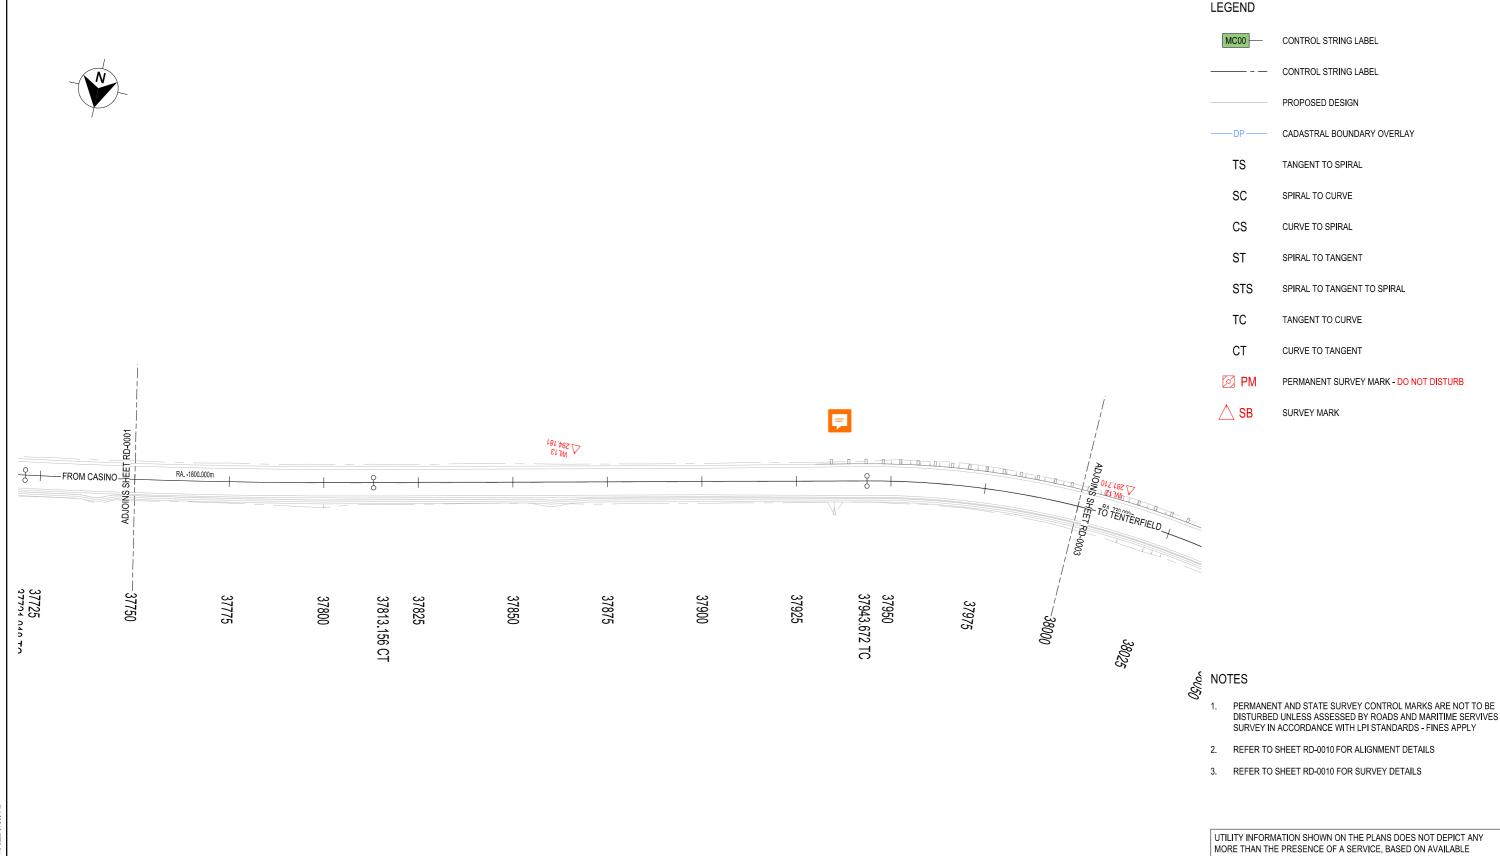

DRAWINGS / DESIGN PREPARED BY

TRANSPORT FOR NSW

40 INFRASTRUCTURE & PLACE

ENGINEERING SERVICES

ROAD DESIGN NORTHERN

DESIGN MODEL FILE(S) USED FOR DOCUMENTATION OF THIS DRAWING

30

HEIGHT DATUM

HW16_MallanganeeRangeWillock_Design_IFC_V1.txt

N2019070

WVR No. | APPROVAL | SCALES ON A3 SIZE DRAWING

CO-ORDINATE SYSTEM

MGA ZONE 56

⟨:\PROJECTS\16_BRUXNER HIGHWAY\N2019070 Mallanganee Range and W≣ock st \$5390_\$5400\DRAWINGS\Final\D\$2020-000063-02-RA.dgn

EXTERNAL REFERENCE FILES

REV DATE AMENDMENT / REVISION DESCRIPTION

UTILITY INFORMATION SHOWN ON THE PLANS DOES NOT DEPICT ANY

DOCUMENTARY EVIDENCE. THE PRESENCE OF A UTILITY SERVICE, ITS SIZE AND LOCATION SHOULD BE CONFIRMED BY FIELD INSPECTION, PRIOR TO THE COMMENCEMENT OF ROADWORKS AND THE RELEVANT UTILITY PLANS OBTAINED BY DIALLING PH 1100 OR FAX 1300 652 077 (DIAL BEFORE YOU DIG). CAUTION SHOULD BE EXERCISED WHEN WORKING IN THE VICINITY OF ALL UTILITY SERVICES.

NOT FOR CONSTRUCTION

KYOGLE COUNCIL HW16 - BRUXNER HIGHWAY

for NSW

11/07/2022 1:11:53 PM

TITLE

DRAWN

DESIGN

DRG CHECK

DESIGN MANAGER

tightd

D. TIGHT

D. TIGHT

PROJECT MANAGER R. GERSERKOWSKI

D.JOHNSON


D.JOHNSON

D.JOHNSON


Transport MALLANGANEE RANGE - WILLOCK STREET S5390-5400 37.52km TO 39.66km FROM CASINO

ROAD ALIGNMENT PLAN HW16 - BRUXNER HIGHWAY - MC00 - 37750 TO 38000

DS2020/000063 TfNSW REGISTRATION No. REGIONAL MAINTENANCE
REGIONAL MAINTENANCE DELIVERY NORTHERN ISSUE STATUS
PROJECT MANAGEMENT NORTHERN DETAIL DES RD-0002 DETAIL DESIGN

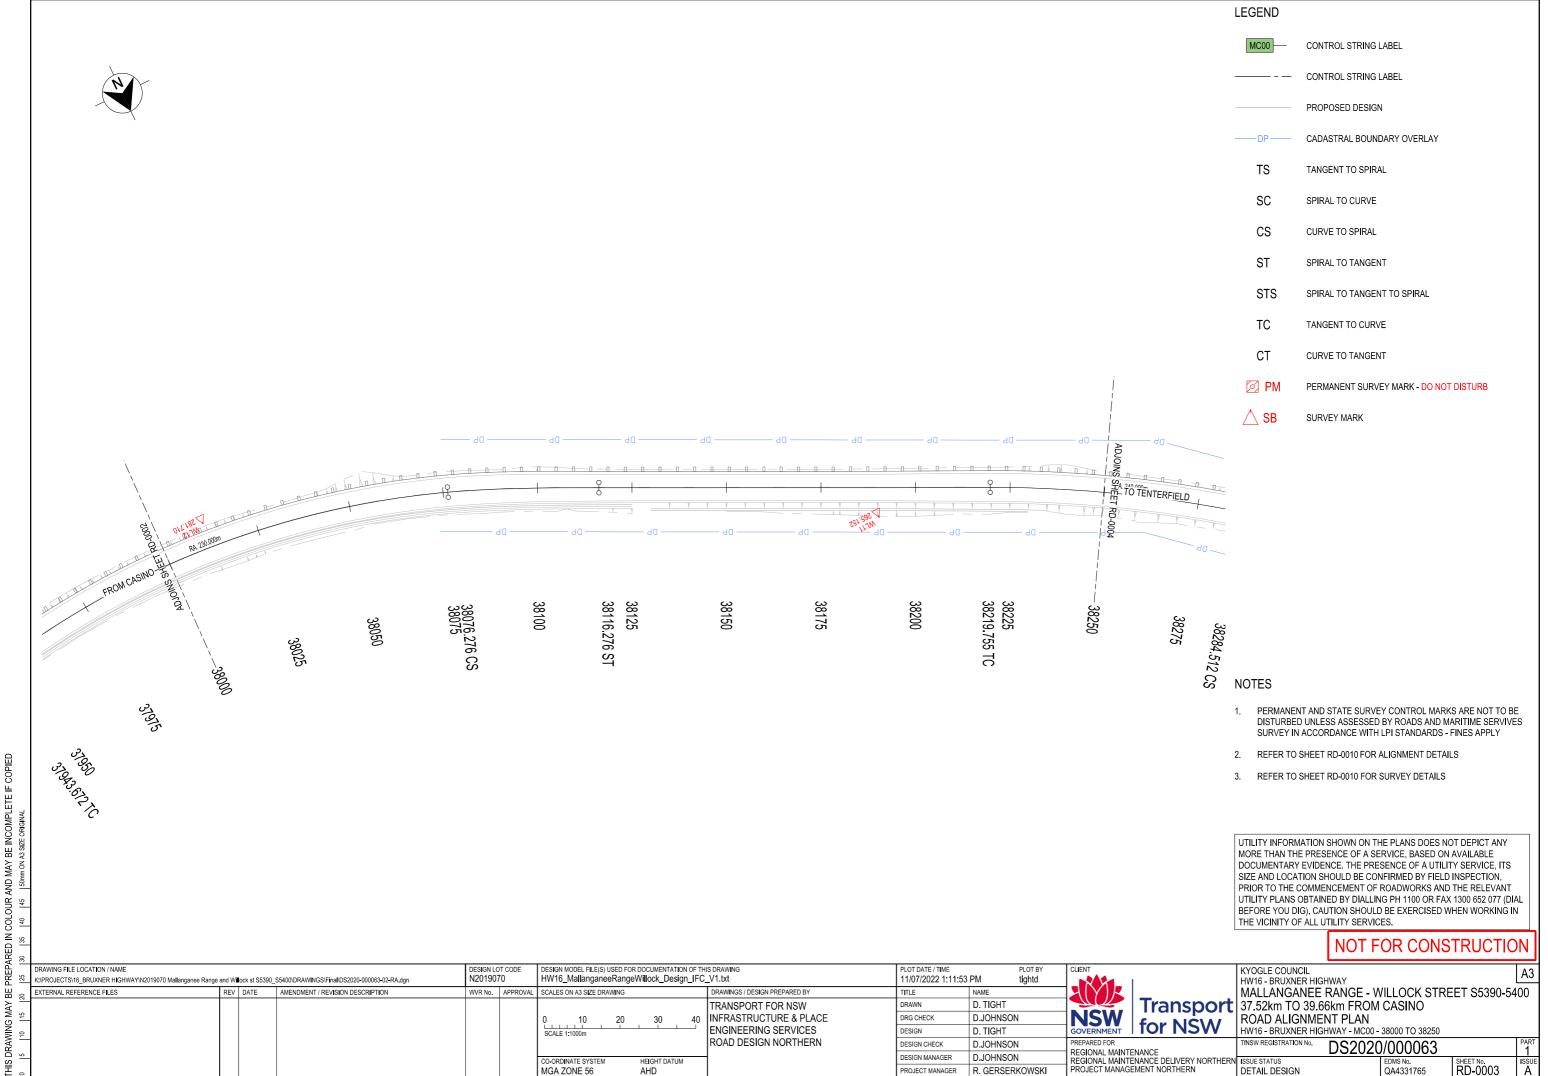

RD-0003 A
© Transport for NSW

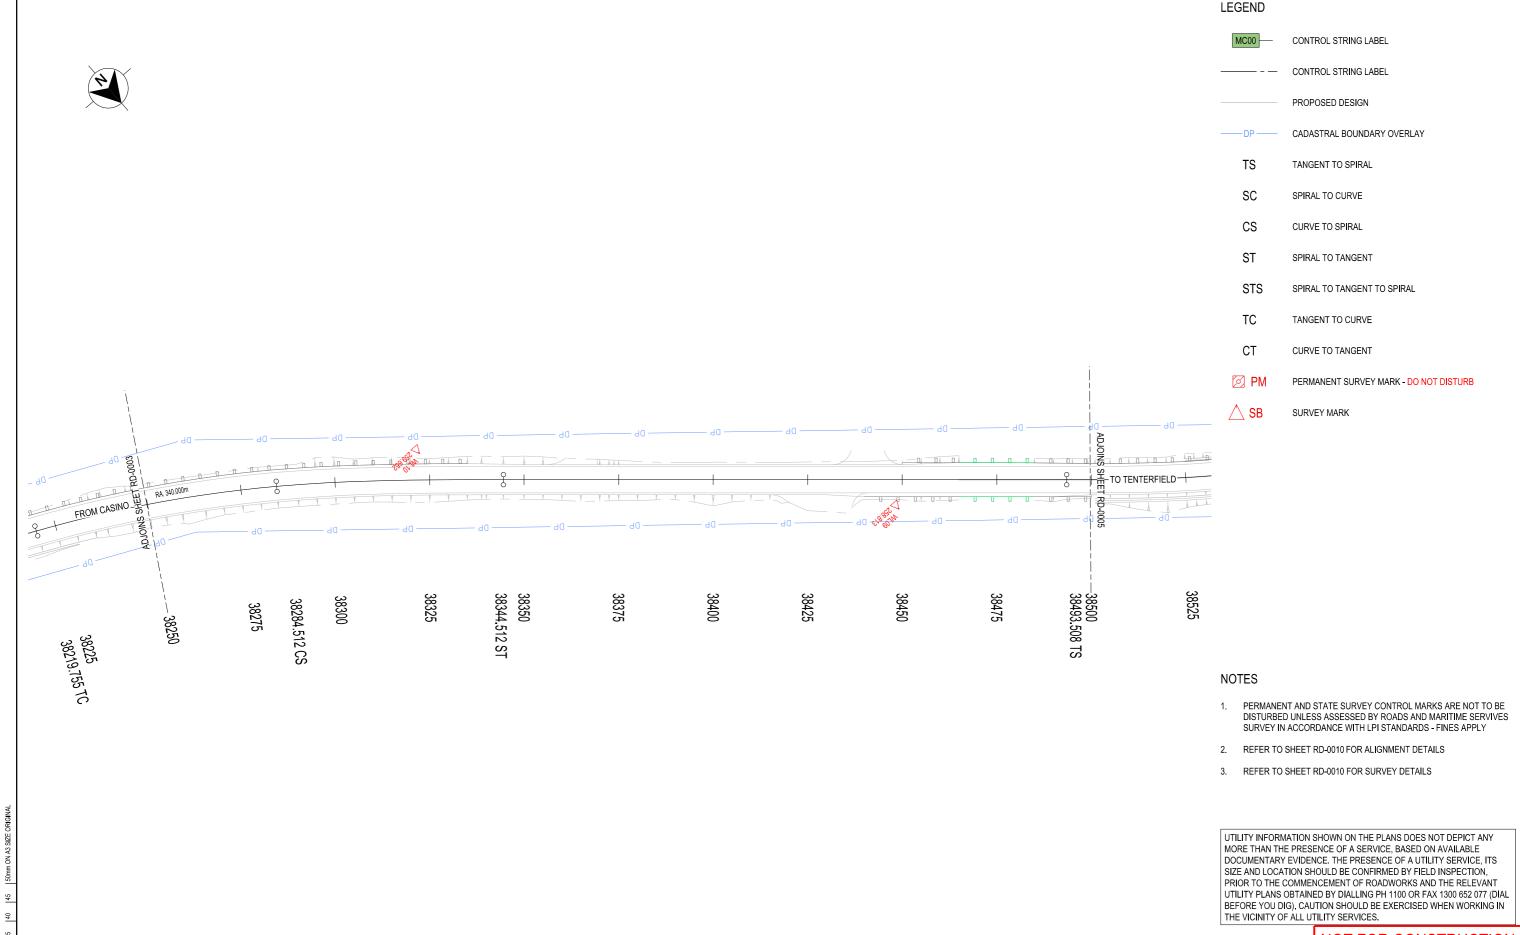

DRAWINGS / DESIGN PREPARED BY

TRANSPORT FOR NSW

40 INFRASTRUCTURE & PLACE

ENGINEERING SERVICES

ROAD DESIGN NORTHERN

11/07/2022 1:11:54 PM

TITLE

DRAWN

DESIGN

DRG CHECK

DESIGN MANAGER

tightd

PROJECT MANAGEMENT NORTHERN

D. TIGHT

D. TIGHT

PROJECT MANAGER R. GERSERKOWSKI

D.JOHNSON

D.JOHNSON

D.JOHNSON

DESIGN MODEL FILE(S) USED FOR DOCUMENTATION OF THIS DRAWING

30

HEIGHT DATUM

HW16_MallanganeeRangeWillock_Design_IFC_V1.txt

SCALES ON A3 SIZE DRAWING

CO-ORDINATE SYSTEM

MGA ZONE 56

N2019070

WVR No. APPROVAL

⟨:\PROJECTS\16_BRUXNER HIGHWAY\N2019070 Mallanganee Range and W≣ock st \$5390_\$5400\DRAWINGS\Final\D\$2020-000063-02-RA.dgn

EXTERNAL REFERENCE FILES


REV DATE AMENDMENT / REVISION DESCRIPTION

NOT FOR CONSTRUCTION

for NSW

KYOGLE COUNCIL HW16 - BRUXNER HIGHWAY Transport MALLANGANEE RANGE - WILLOCK STREET S5390-5400 37.52km TO 39.66km FROM CASINO ROAD ALIGNMENT PLAN HW16 - BRUXNER HIGHWAY - MC00 - 38250 TO 38500

DS2020/000063 TfNSW REGISTRATION No. REGIONAL MAINTENANCE
REGIONAL MAINTENANCE DELIVERY NORTHERN ISSUE STATUS RD-0004 DETAIL DESIGN

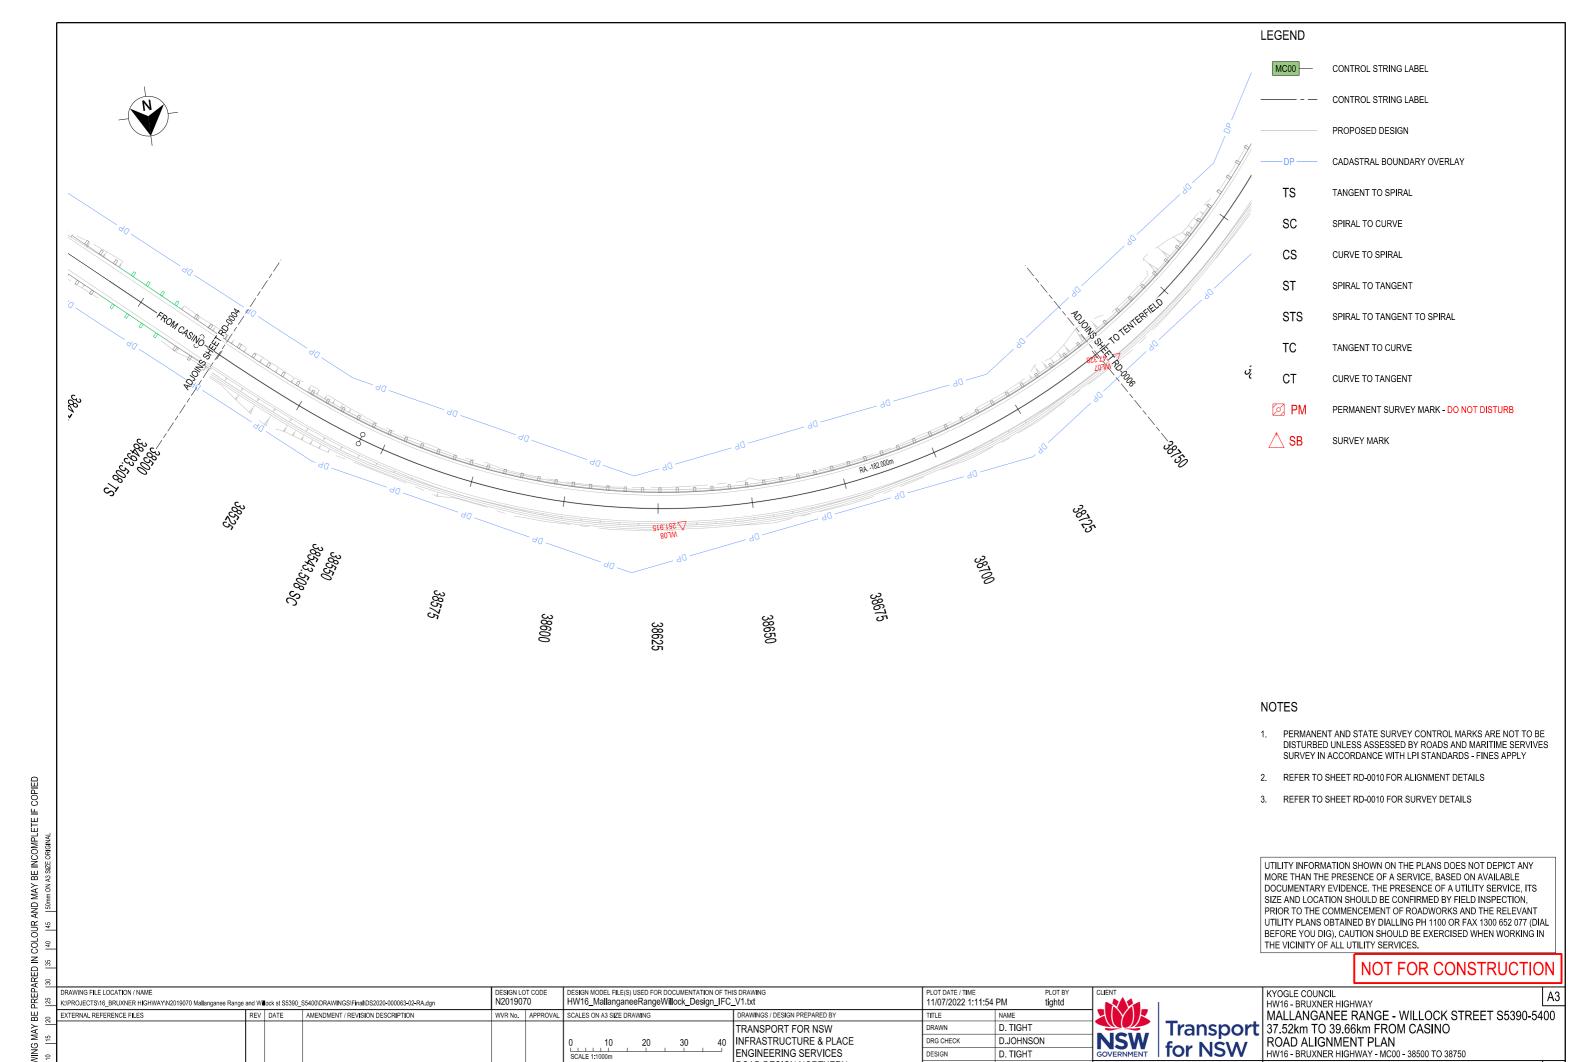

ROAD DESIGN NORTHERN

HEIGHT DATUM

MGA ZONE 56

DESIGN

DESIGN MANAGER

D. TIGHT

D.JOHNSON

D.JOHNSON

R. GERSERKOWSKI


RD-0005


DS2020/000063


TfNSW REGISTRATION No.

DETAIL DESIGN

REGIONAL MAINTENANCE
REGIONAL MAINTENANCE DELIVERY NORTHERN ISSUE STATUS
PROJECT MANAGEMENT NORTHERN DETAIL DES

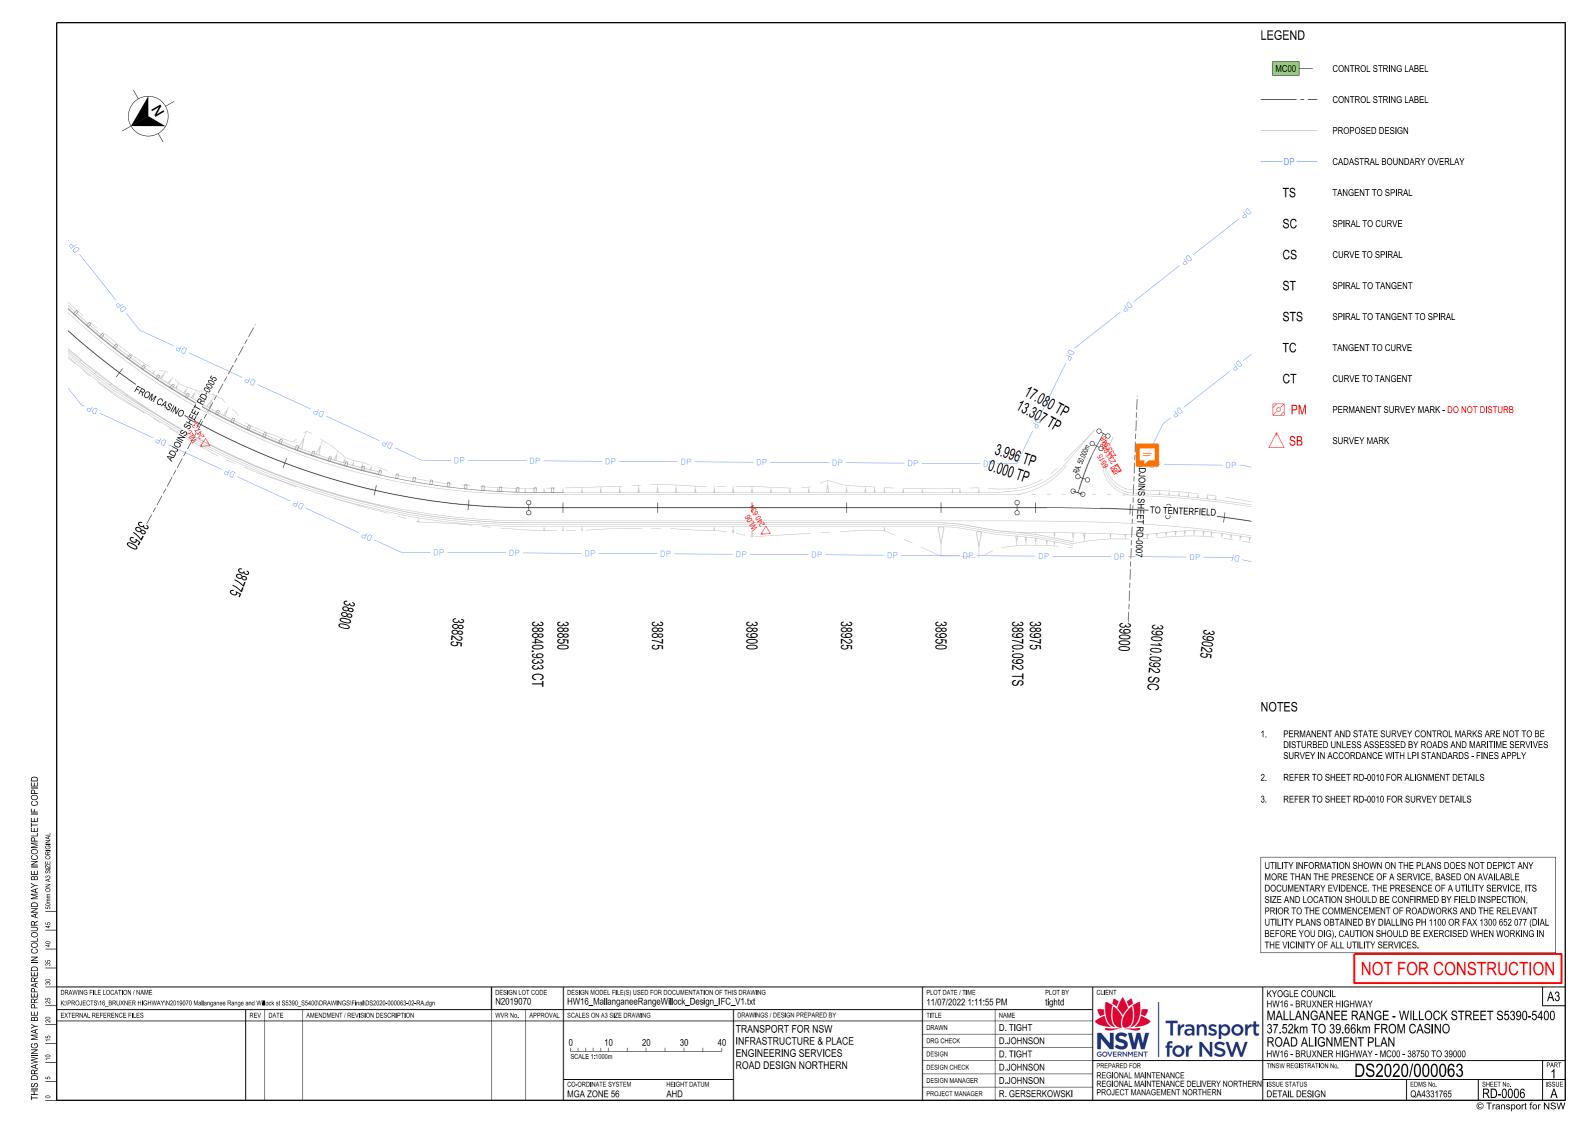

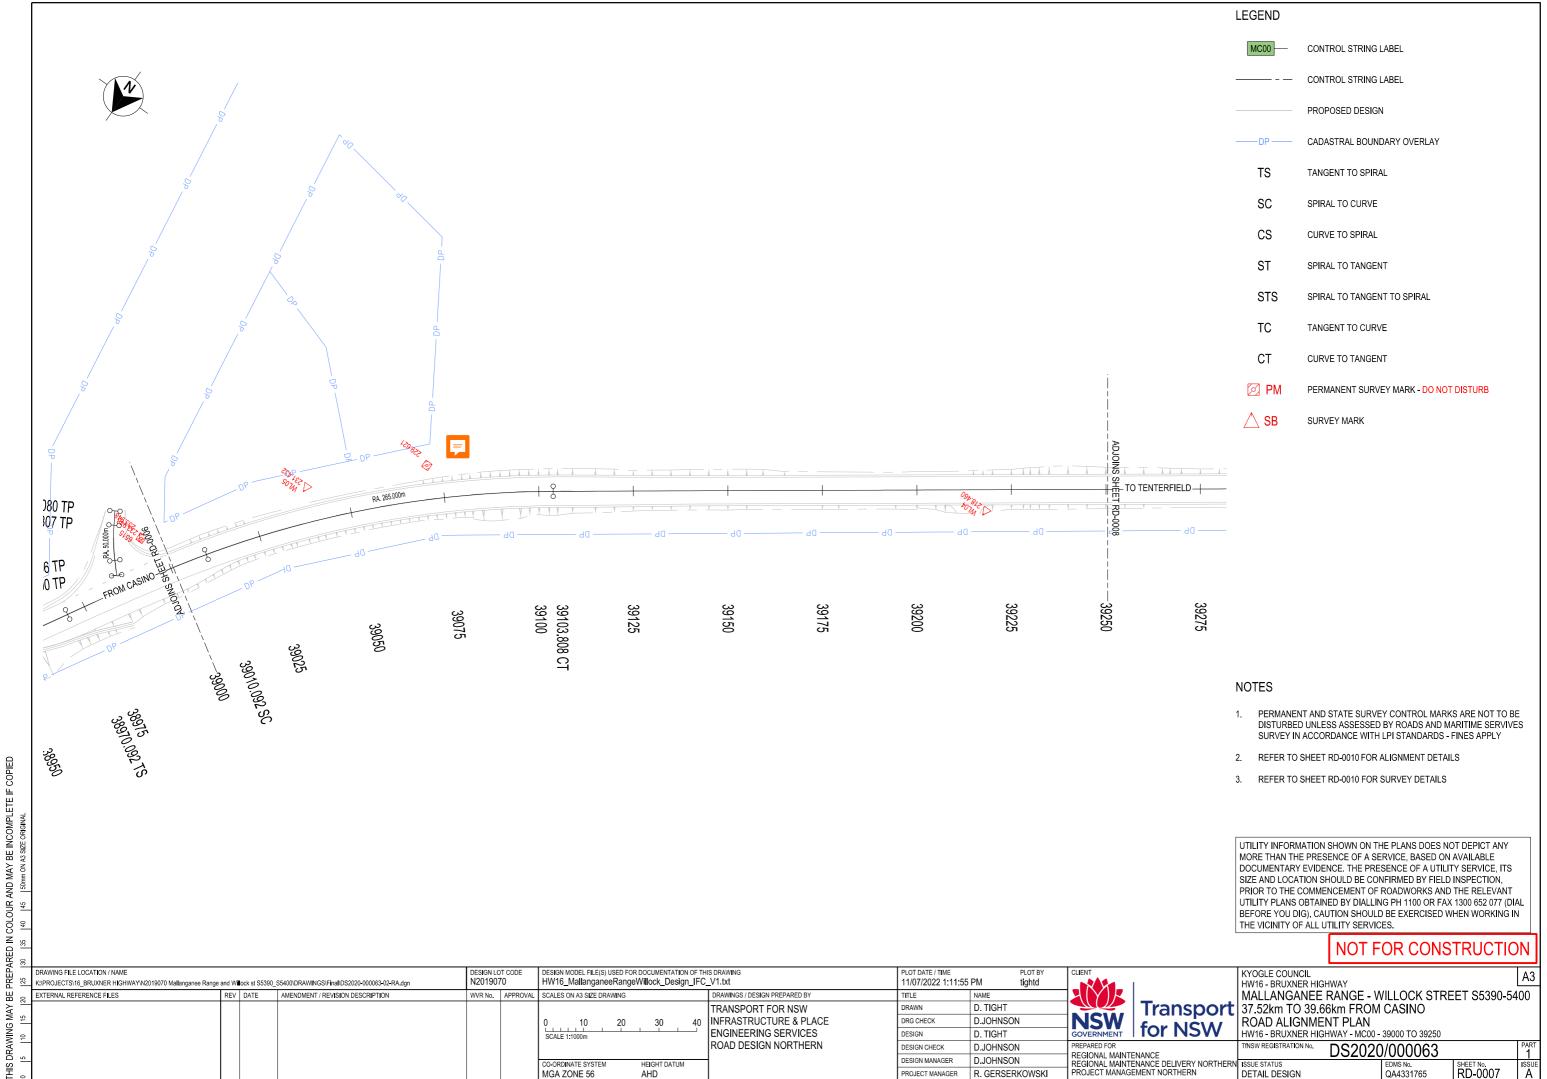

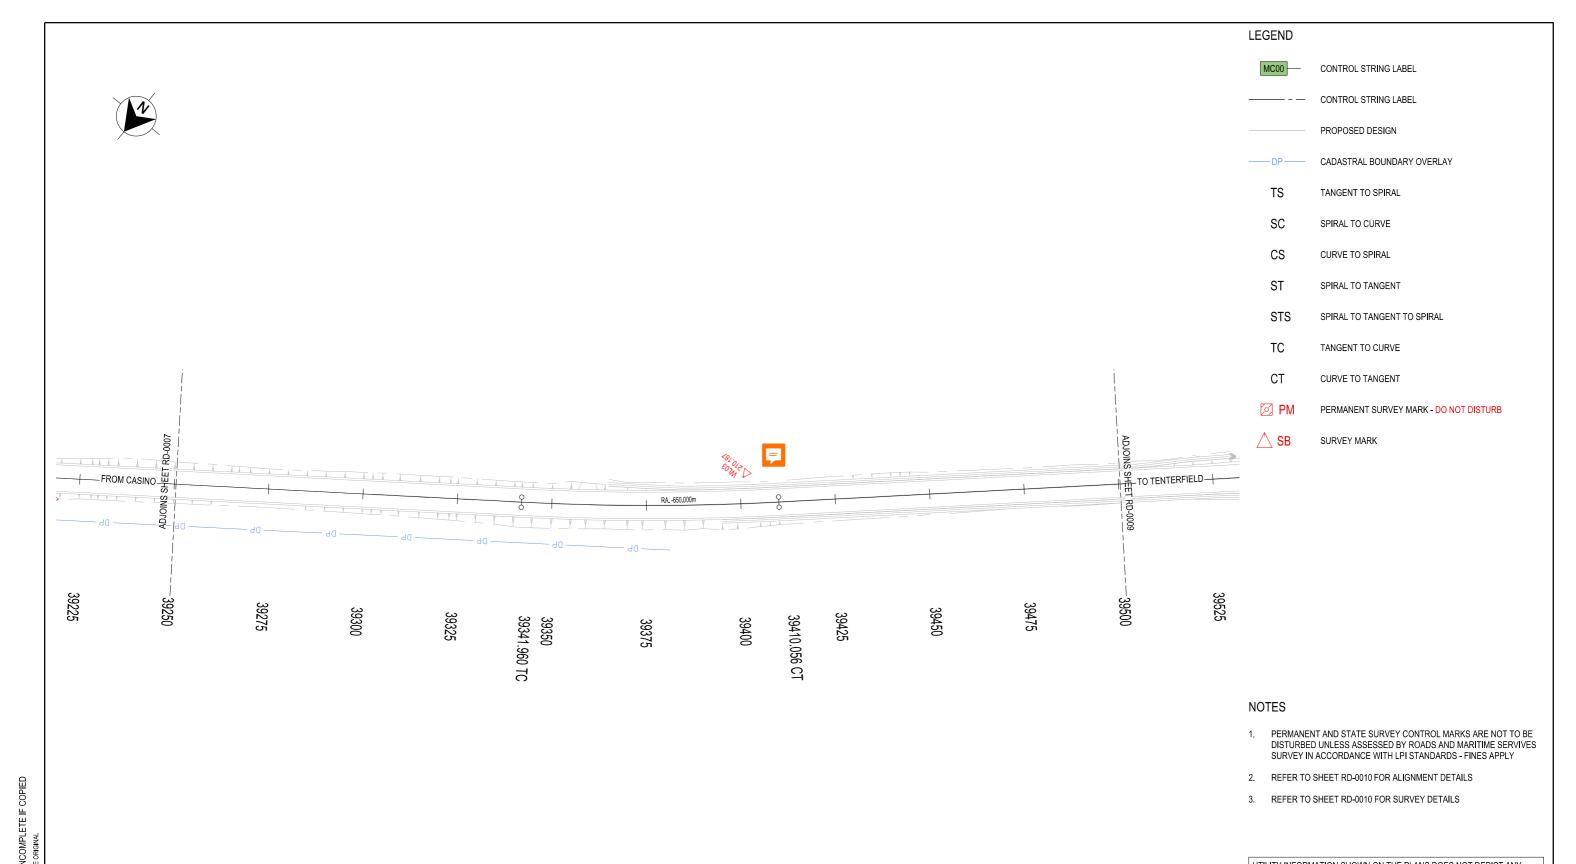

UTILITY INFORMATION SHOWN ON THE PLANS DOES NOT DEPICT ANY MORE THAN THE PRESENCE OF A SERVICE, BASED ON AVAILABLE DOCUMENTARY EVIDENCE. THE PRESENCE OF A UTILITY SERVICE, ITS SIZE AND LOCATION SHOULD BE CONFIRMED BY FIELD INSPECTION, PRIOR TO THE COMMENCEMENT OF ROADWORKS AND THE RELEVANT UTILITY PLANS OBTAINED BY DIALLING PH 1100 OR FAX 1300 652 077 (DIAL BEFORE YOU DIG). CAUTION SHOULD BE EXERCISED WHEN WORKING IN THE VICINITY OF ALL UTILITY SERVICES.

NOT FOR CONSTRUCTION


DESIGN MODEL FILE(S) USED FOR DOCUMENTATION OF THIS DRAWING 11/07/2022 1:11:55 PM ⟨:\PROJECTS\16_BRUXNER HIGHWAY\N2019070 Mallanganee Range and W≣ock st \$5390_\$5400\DRAWINGS\Final\D\$2020-000063-02-RA.dgn N2019070 HW16_MallanganeeRangeWillock_Design_IFC_V1.txt tightd REV DATE AMENDMENT / REVISION DESCRIPTION DRAWINGS / DESIGN PREPARED BY SCALES ON A3 SIZE DRAWING EXTERNAL REFERENCE FILES WVR No. APPROVAL TITLE D. TIGHT TRANSPORT FOR NSW DRAWN 40 INFRASTRUCTURE & PLACE DRG CHECK D.JOHNSON 30 for NSW ENGINEERING SERVICES DESIGN D. TIGHT ROAD DESIGN NORTHERN D.JOHNSON REGIONAL MAINTENANCE
REGIONAL MAINTENANCE DELIVERY NORTHERN ISSUE STATUS
PROJECT MANAGEMENT NORTHERN DETAIL DES DESIGN MANAGER D.JOHNSON CO-ORDINATE SYSTEM HEIGHT DATUM MGA ZONE 56 PROJECT MANAGER R. GERSERKOWSKI

KYOGLE COUNCIL HW16 - BRUXNER HIGHWAY

Transport MALLANGANEE RANGE - WILLOCK STREET S5390-5400 37.52km TO 39.66km FROM CASINO

ROAD ALIGNMENT PLAN HW16 - BRUXNER HIGHWAY - MC00 - 39250 TO 39500

DS2020/000063 TfNSW REGISTRATION No. RD-0008 DETAIL DESIGN

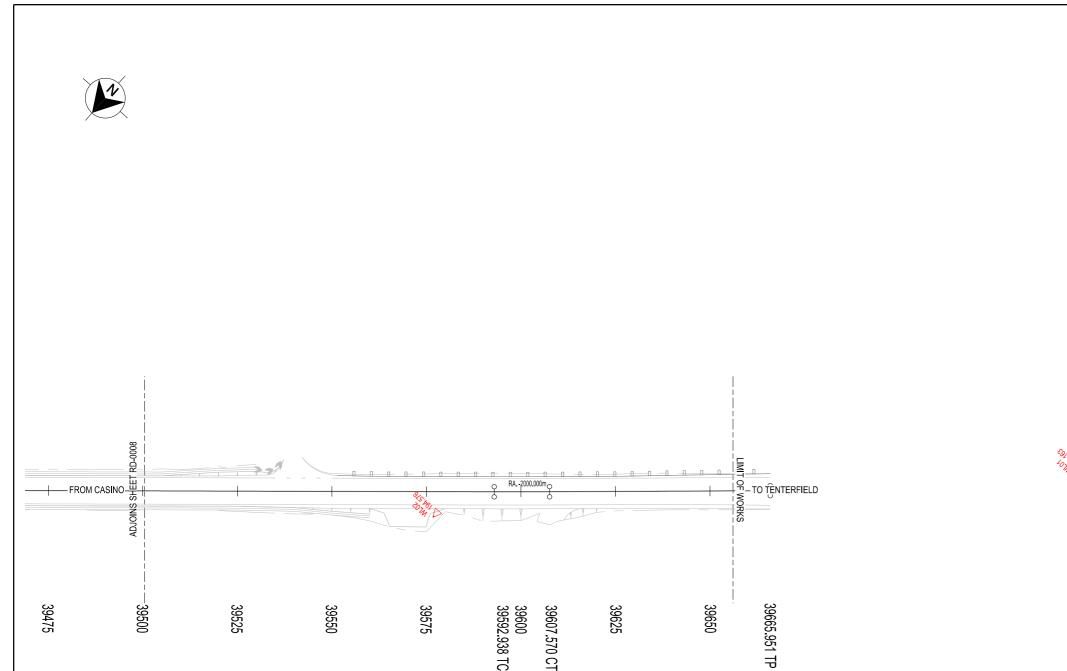



CONTROL STRING LABEL CONTROL STRING LABEL PROPOSED DESIGN CADASTRAL BOUNDARY OVERLAY TS TANGENT TO SPIRAL SC SPIRAL TO CURVE CS CURVE TO SPIRAL ST SPIRAL TO TANGENT SPIRAL TO TANGENT TO SPIRAL TC TANGENT TO CURVE CURVE TO TANGENT CT PERMANENT SURVEY MARK - DO NOT DISTURB

SURVEY MARK



NOTES

- PERMANENT AND STATE SURVEY CONTROL MARKS ARE NOT TO BE DISTURBED UNLESS ASSESSED BY ROADS AND MARITIME SERVIVES SURVEY IN ACCORDANCE WITH LPI STANDARDS - FINES APPLY
- REFER TO SHEET RD-0010 FOR ALIGNMENT DETAILS
- 3. REFER TO SHEET RD-0010 FOR SURVEY DETAILS

UTILITY INFORMATION SHOWN ON THE PLANS DOES NOT DEPICT ANY MORE THAN THE PRESENCE OF A SERVICE, BASED ON AVAILABLE DOCUMENTARY EVIDENCE. THE PRESENCE OF A UTILITY SERVICE, ITS SIZE AND LOCATION SHOULD BE CONFIRMED BY FIELD INSPECTION, PRIOR TO THE COMMENCEMENT OF ROADWORKS AND THE RELEVANT UTILITY PLANS OBTAINED BY DIALLING PH 1100 OR FAX 1300 652 077 (DIAL BEFORE YOU DIG). CAUTION SHOULD BE EXERCISED WHEN WORKING IN THE VICINITY OF ALL UTILITY SERVICES.

NOT FOR CONSTRUCTION

DESIGN MODEL FILE(S) USED FOR DOCUMENTATION OF THIS DRAWING 11/07/2022 1:11:56 PM ⟨:\PROJECTS\16_BRUXNER HIGHWAY\N2019070 Mallanganee Range and W≣ock st \$5390_\$5400\DRAWINGS\Final\D\$2020-000063-02-RA.dgn N2019070 HW16_MallanganeeRangeWillock_Design_IFC_V1.txt tightd REV DATE AMENDMENT / REVISION DESCRIPTION SCALES ON A3 SIZE DRAWING DRAWINGS / DESIGN PREPARED BY WVR No. APPROVAL TITLE D. TIGHT TRANSPORT FOR NSW DRAWN 40 INFRASTRUCTURE & PLACE DRG CHECK D.JOHNSON 30 ENGINEERING SERVICES DESIGN D. TIGHT ROAD DESIGN NORTHERN D.JOHNSON REGIONAL MAINTENANCE
REGIONAL MAINTENANCE DELIVERY NORTHERN ISSUE STATUS
PROJECT MANAGEMENT NORTHERN DETAIL DES DESIGN MANAGER D.JOHNSON

HEIGHT DATUM

CO-ORDINATE SYSTEM

MGA ZONE 56

EXTERNAL REFERENCE FILES

for NSW

PROJECT MANAGER R. GERSERKOWSKI

Transport MALLANGANEE RANGE - WILLOCK STREET S5390-5400 37.52km TO 39.66km FROM CASINO

ROAD ALIGNMENT PLAN HW16 - BRUXNER HIGHWAY - MC00 - 39500 TO 39665

KYOGLE COUNCIL HW16 - BRUXNER HIGHWAY

DS2020/000063 TfNSW REGISTRATION No. DETAIL DESIGN

RD-0009

SURVEY SCHEDULE

				SURVEY CONTROL						
STRING				H.CLASS	HEIGHT	V.CLASS		COMBINE	D	
	STATION	EASTING	NORTHING	/ORDER SOURCE		ORDER SOURCE	DATE	S.FACTOR	DESCRIPTION	
=====										====
WL02	WL02	472428.8100	6802465.448	30 RMS	194.5760) RMS	09/09/19	0.999560	STAR PICKET	[C]
WL01	WL01	472309.2010	6802343.562	LO RMS	184.1630) RMS	09/09/19	0.999560	STAR PICKET	[C]
WL03	WL03	472569.4977	6802571.864	43 RMS	210.1869	9 RMS	09/09/19	0.999560	STAR PICKET	[C]
WL04	WL04	472708.6047	6802691.413	LO RMS	218.4604	4 RMS	09/09/19	0.999560	STAR PICKET	[C]
WL05	WL05	472858.7162	6802790.317	75 RMS	231.4319	RMS	09/09/19	0.999560	STAR PICKET	[C]
WL06	WL06	472918.3945	6802915.177	70 RMS	240.6339	RMS	09/09/19	0.999560	STAR PICKET	[C]
WL07	WL07	473012.2991	6803032.209	95 RMS	247.3277	7 RMS	09/09/19	0.999560	NAIL IN CONC	[C]
WL08	WL08	473131.8607	6803061.246	S1 RMS	251.9151	L RMS	09/09/19	0.999560	NAIL IN CONC	[C]
WL09	WL09	473290.7067	6802971.566	S2 RMS	258.8127	7 RMS	09/09/19	0.999560	STAR PICKET	[C]
WL10	WL10	473376.2004	6802876.754	41 RMS	259.6523	3 RMS	09/09/19	0.999560	STAR PICKET	[C]
WL11	WL11	473495.7458	6802819.733	LO RMS	265.1521	L RMS	09/09/19	0.999560	STAR PICKET	[C]
WL12	WL12	473657.9908	6802744.507	70 RMS	281.7098	3 RMS	09/09/19	0.999560	STAR PICKET	[C]
WL13	WL13	473803.5515	6802765.482	26 RMS	294.1808	3 RMS	09/09/19	0.999560	STAR PICKET	[C]
WL14	WL14	473974.0618	6802818.552	29 RMS	308.5898	3 RMS	09/09/19	0.999560	STAR PICKET	[c]
WL15	WL15	474083.7337	6802818.839	93 RMS	314.8073	3 RMS	09/09/19	0.999560	STAR PICKET	[c]
WL16	WL16	474184.0715	6802840.632		321.4009		09/09/19	0.999560	STAR PICKET	[c]

Mean Combined Scale Factor (CSF) = 0.999560


- [P] = Permanent Mark must be protected during construction in accordance with Specification G71
 [C] = Suitable for construction and must not be disturbed until assessment by Surveyor
 [N] = Not suitable for construction as Survey Mark may be unstable


 * = Last four characters of the Permanent Mark number or four character descriptor used in DTM

ALIGNMENT SCHEDULE

		HORIZONTAL ALI	GNMENT MC00		
NAI	ME -CHARACTERISTIC	SLENGTH	-CHAINAGE-	X	Y
1	BEARING= 266 17 11.5	2 693	37519.242	474143.43351	6802834.5633
·	XC = 474158.88115 YC = 6802554.97680 R = -280.000		37521.935		6802834.3889
3	BEARING= 260 36 27.3	151.504		474113.18639	
4	XC = 474257.46516 YC = 6801030.62948 R = -1800.000	96.124	37701.192		6802806.4982
5	BEARING= 257 32 52.2	144.649	37797.316	473869.34116	6802788.2869
6	XC = 473676.34512 YC = 6802991.45144 R = 240.000	138.621	37941.965		6802757.0971
6	A = 97.97959	40.000	38080.586	473591.74142	6802766.858
7	BEARING= 295 24 57.2	101.431	38120.586	473555.16121	6802783.0104
8	XC = 473600.88634 YC = 6803115.57246 R = 320.000	88.942	38222.018		6802826.5432
9	BEARING= 311 20 26.9	176.563	38310.959	473389.51462	6802875.3184
9	A = 104.78550	60.000	38487.522	473256.95211	6802991.9448
10	XC = 473113.02935 YC = 6802873.73314 R = -183.000	294.196		473209.86385	
11	BEARING= 209 50 15.5	129.966	38841.719	472954.28803	6802964.7836
11	A = 102.95630	40.000	38971.685	472889.62411	6802852.0458
12	XC = 472649.58564 YC = 6802966.67459 R = 265.000	94.649	39011.685	472868.86115	6802817.8685
13	BEARING= 234 37 33.5	258 124	39106.334	472802.99723	6802750.5961
	XC = 472708.30789 YC = 6802438.08721 R = -200.000		39364.458	472592.52556	6802601.1652
 15	BEARING= 228 16 22.6	269.018	39386.634	472575.19135	6802587.3520
			39655 652	472374 41676	6802408.2983

ARED I	3											NOT F	OR CON	STRUCTIC)N
급 _	DRAWING FILE LOCATION / NAME			DESIGN LOT CODE	DESIGN MODEL FILE(S) USED			PLOT DATE / TIME	PLOT BY	CLIENT		KYOGLE COUNCIL			Δ3
PR 125	K:\PROJECTS\16_BRUXNER HIGHWAY\N2019070 Mallanganee	Range and Willock st S5390	_S5400\DRAWINGS\Final\DS2020-000063-02-RA.dgn	N2019070	HW16_MallanganeeRar	igeWillock_Design_IFC	_V1.txt	11/07/2022 1:11:56	PM tightd			HW16 - BRUXNER HIGHWAY			
Н 🕺	EXTERNAL REFERENCE FILES	REV DATE	AMENDMENT / REVISION DESCRIPTION	WVR No. APPROVAL	SCALES ON A3 SIZE DRAWING	ı	DRAWINGS / DESIGN PREPARED BY	TITLE	NAME		<u> </u>	MALLANGANEE RANGE - V	VILLOCK STF	REET S5390-54	400
` ¥	`						TRANSPORT FOR NSW	DRAWN	D. TIGHT		Transport	37.52km TO 39.66km FROM	CASINO		
Z 5	2						INFRASTRUCTURE & PLACE	DRG CHECK	D.JOHNSON			ROAD ALIGNMENT PLAN			
N P	2						ENGINEERING SERVICES	DESIGN	D. TIGHT	GOVERNMENT		SURVEY AND ALLIGNMENT SHEDUL	E		
- Æ	7						ROAD DESIGN NORTHERN	DESIGN CHECK	D.JOHNSON	PREPARED FOR		TfNSW REGISTRATION No. DS2020	0/000063		PART 1
5	<u>-</u>				CO-ORDINATE SYSTEM	HEIGHT DATUM	-	DESIGN MANAGER	D.JOHNSON	REGIONAL MAINT	ENANCE ENANCE DELIVERY NORTHERN		EDMS No.	SHEET No	ISSUE
業 。	,				MGA ZONE 56	AHD		PROJECT MANAGER	R. GERSERKOWSKI			DETAIL DESIGN	QA4331765	RD-0010	Ā

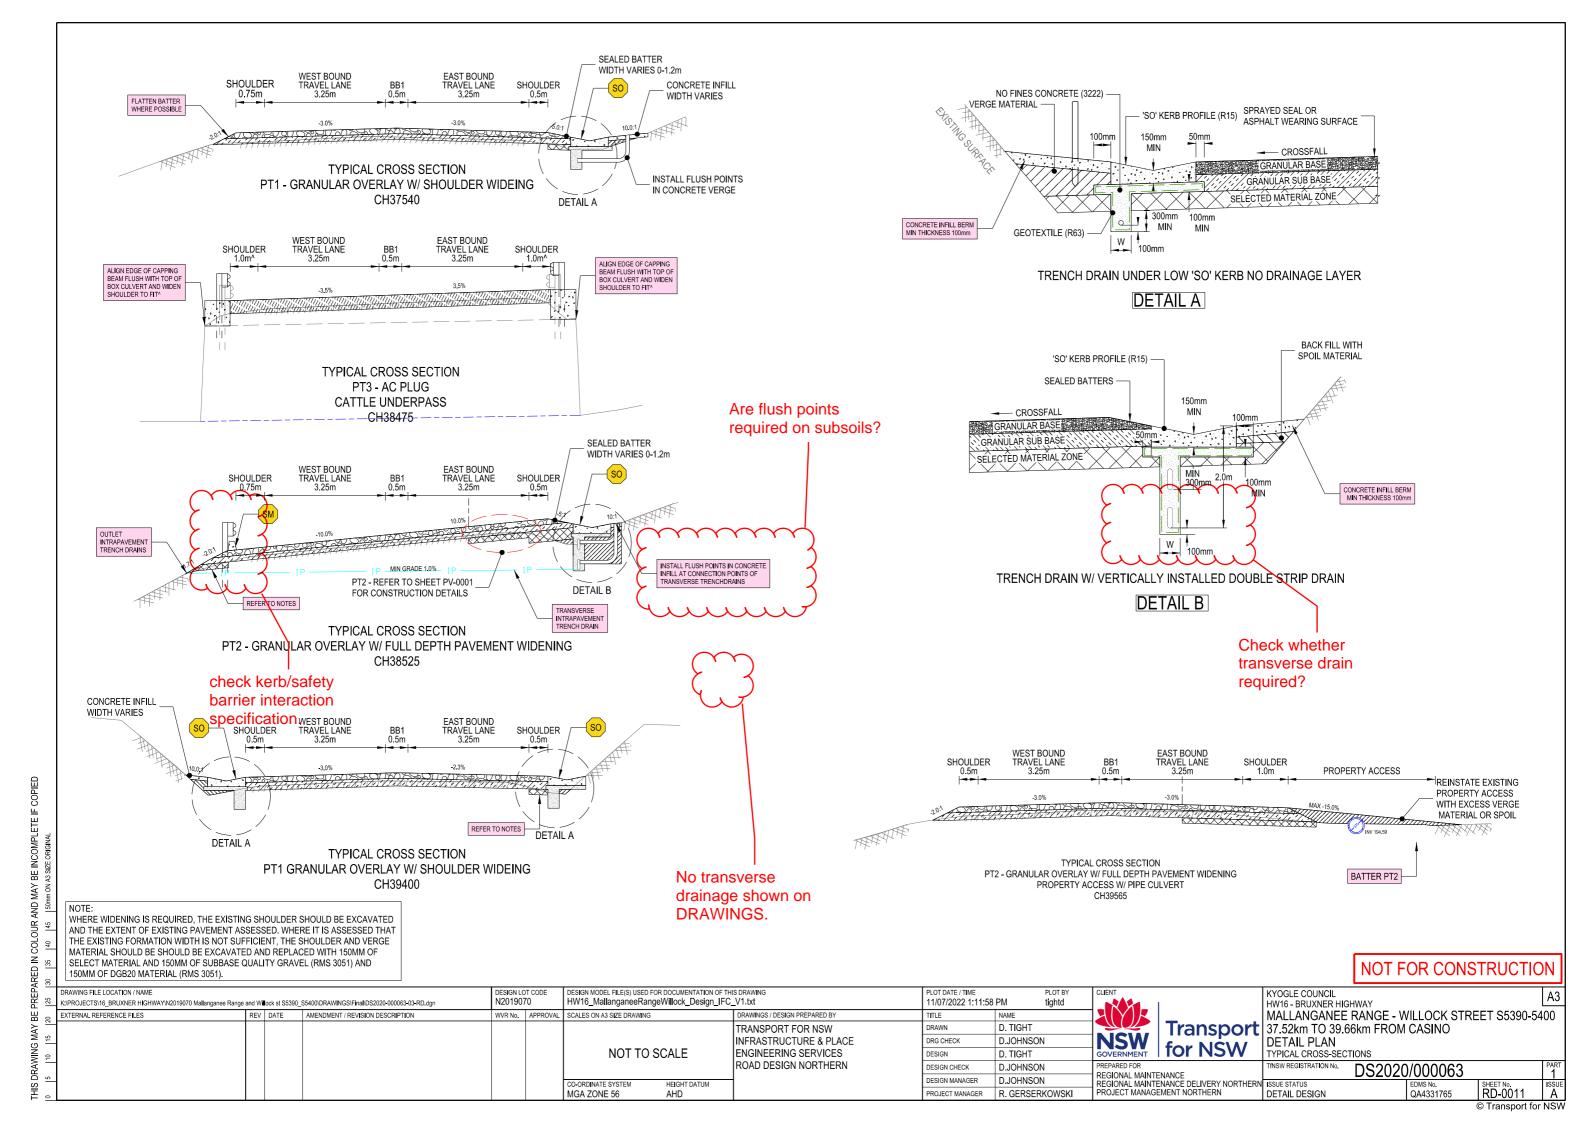

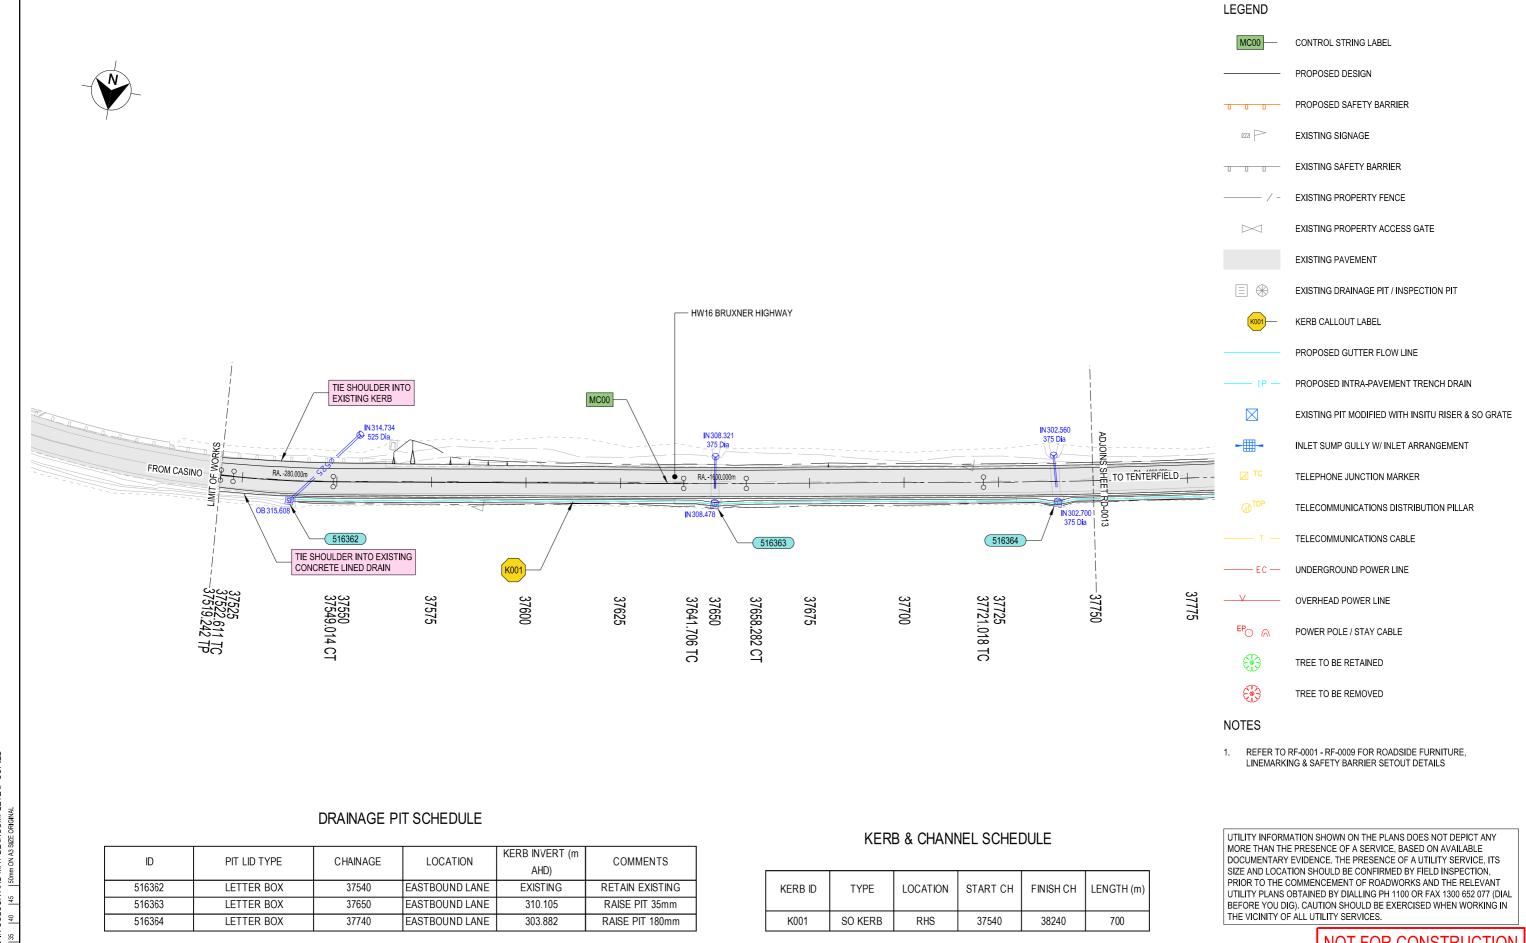


DRAWING FILE LOCATION / NAME K:\PROJECTS\16_BRUXNER HIGHWAY\N2019070 Mallanganee Range	and W a ock st	S5390_S54		DESIGN LOT CODE N2019070 DESIGN MODEL FILE(S) USED FOR DOCUMENTATION OF THIS IN HW16_MallanganeeRangeWillock_Design_IFC_V					PLOT DATE / TIME 11/07/2022 1:11:59	PLOT BY PM tightd	CLIENT		KYOGLE COUNCIL HW16 - BRUXNER HIGH
EXTERNAL REFERENCE FILES	REV DATE	E A	AMENDMENT / REVISION DESCRIPTION	WVR No.	APPROVAL	SCALES ON A3 SIZE DRAWING		DRAWINGS / DESIGN PREPARED BY	TITLE	NAME	RYK		MALLANGANEE F
								TRANSPORT FOR NSW	DRAWN	D. TIGHT		Transport	37.52km TO 39.66
					0 10 20	30 40	INFRASTRUCTURE & PLACE	DRG CHECK	D.JOHNSON	NSW		DETAIL PLAN	
						SCALE 1:1000m		l	DESIGN	D. TIGHT	GOVERNMENT		HW16 - BRUXNER HIGH
								ROAD DESIGN NORTHERN	DESIGN CHECK	D.JOHNSON	PREPARED FOR	5111105	TfNSW REGISTRATION No.
						CO-ORDINATE SYSTEM HEIGHT DATUM			DESIGN MANAGER	D.JOHNSON	REGIONAL MAINT	ENANCE ENANCE DELIVERY NORTHERNI	ISSUE STATUS
						MGA ZONE 56 AHD		PROJECT MANAGER	R. GERSERKOWSKI			DETAIL DESIGN	

EE RANGE - WILLOCK STREET S5390-5400 9.66km FROM CASINO

IGHWAY - MC00 - 37519 TO 37750 DS2020/000063

RD-0012

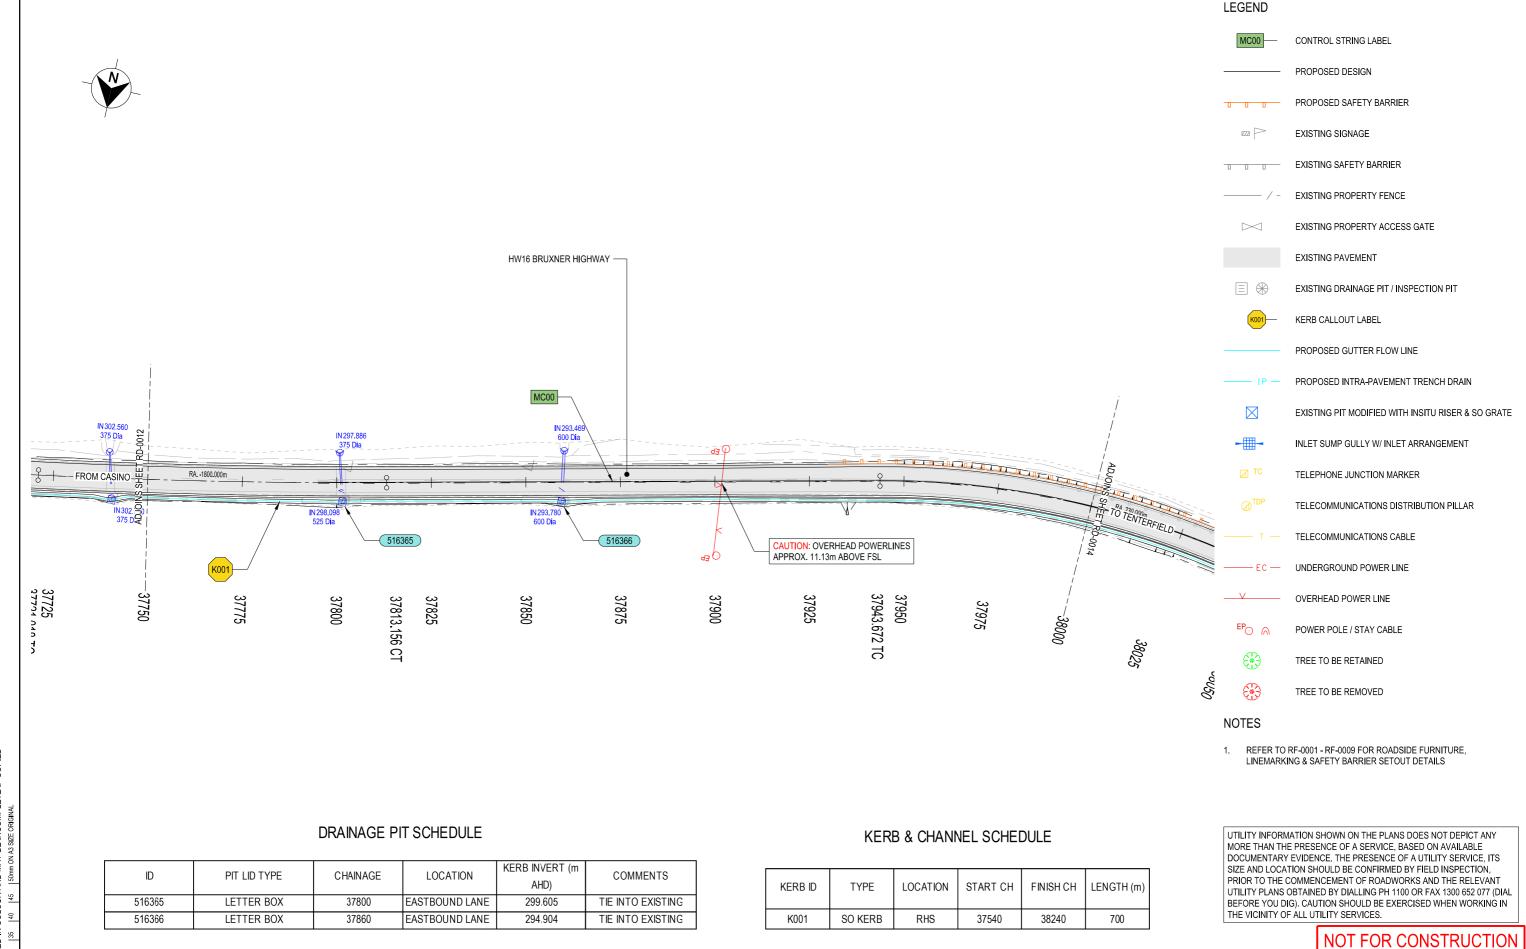

DRAWINGS / DESIGN PREPARED BY

TRANSPORT FOR NSW

INFRASTRUCTURE & PLACE

ENGINEERING SERVICES

ROAD DESIGN NORTHERN

N2019070

WVR No. APPROVAL

REV DATE AMENDMENT / REVISION DESCRIPTION

HW16_MallanganeeRangeWillock_Design_IFC_V1.txt

30

HEIGHT DATUM

SCALES ON A3 SIZE DRAWING

CO-ORDINATE SYSTEM

11/07/2022 1:12:00 PM

TITLE

DRAWN

DESIGN

ORG CHECK

DESIGN MANAGER

tightd

D TIGHT

D. TIGHT

D.JOHNSON

D.JOHNSON

D.JOHNSON

R. GERSERKOWSKI

KYOGLE COUNCIL HW16 - BRUXNER HIGHWAY

TfNSW REGISTRATION No.

for NSW

REGIONAL MAINTENANCE DELIVERY NORTHERN ISSUE STATUS

REGIONAL MAINTENANCE

PROJECT MANAGEMENT NORTHERN


Transport MALLANGANEE RANGE - WILLOCK STREET S5390-5400 37.52km TO 39.66km FROM CASINO


DETAIL PLAN HW16 - BRUXNER HIGHWAY - MC00 - 37750 TO 38000


DS2020/000063


RD-0013


EXTERNAL REFERENCE FILES

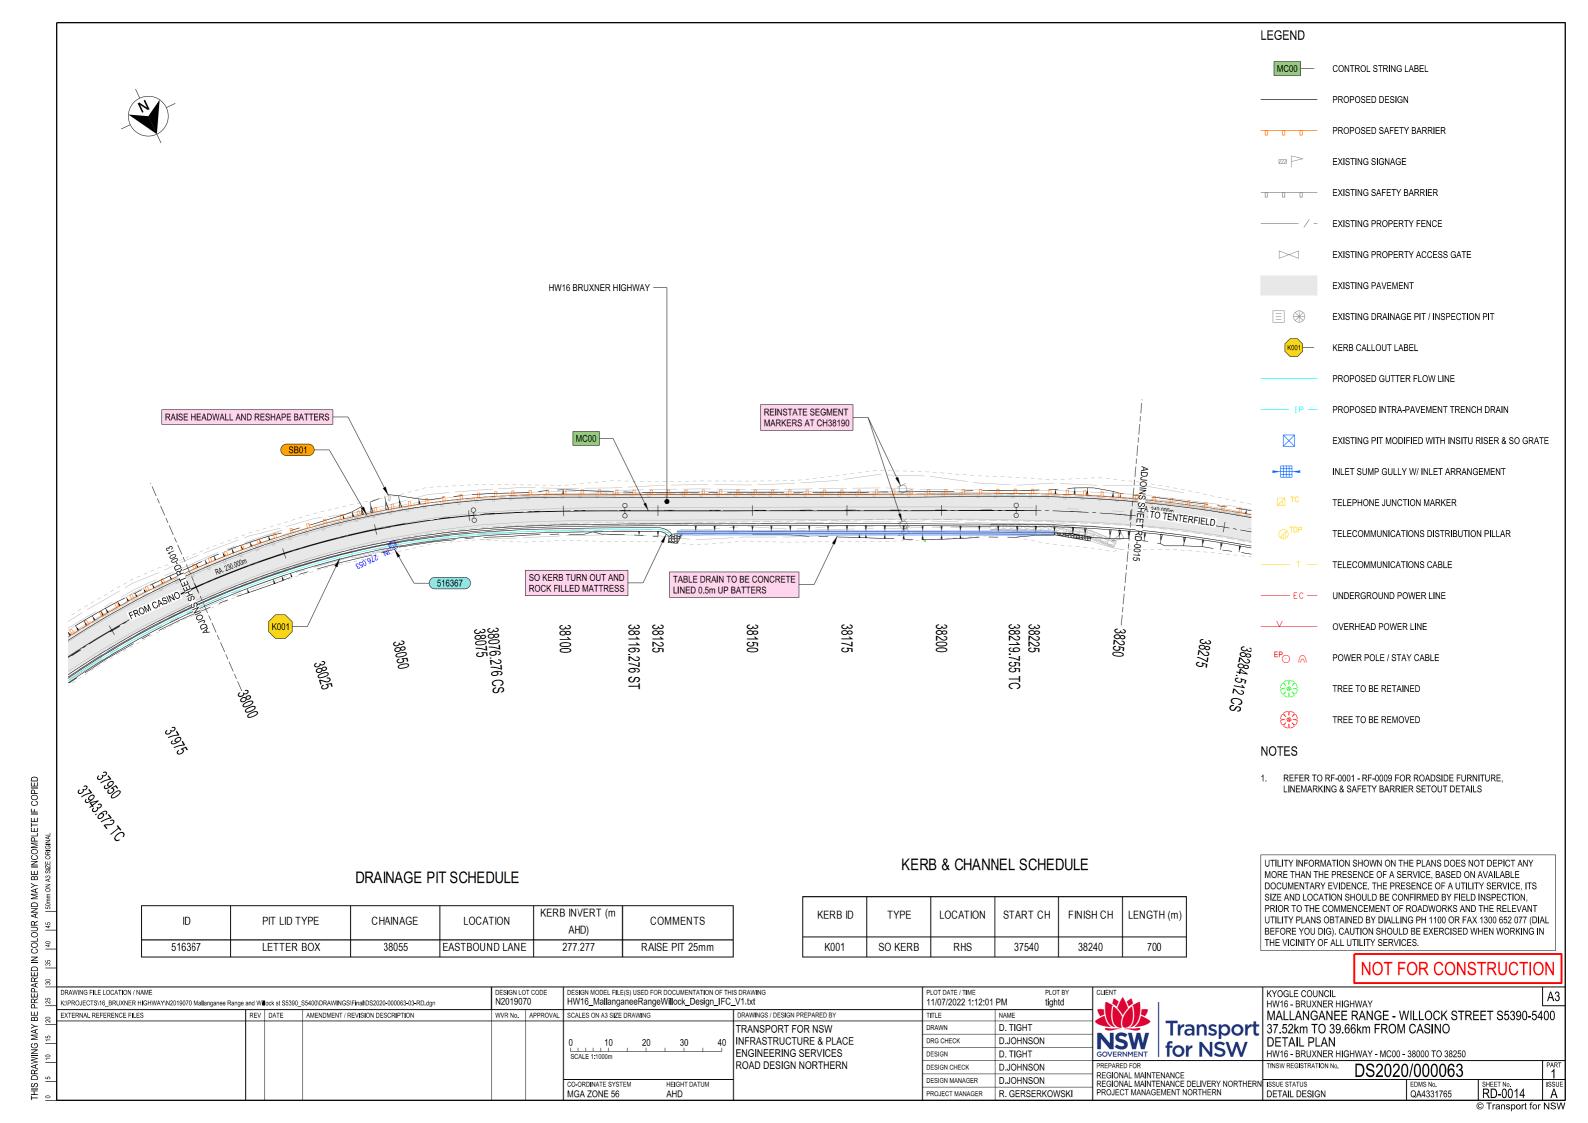


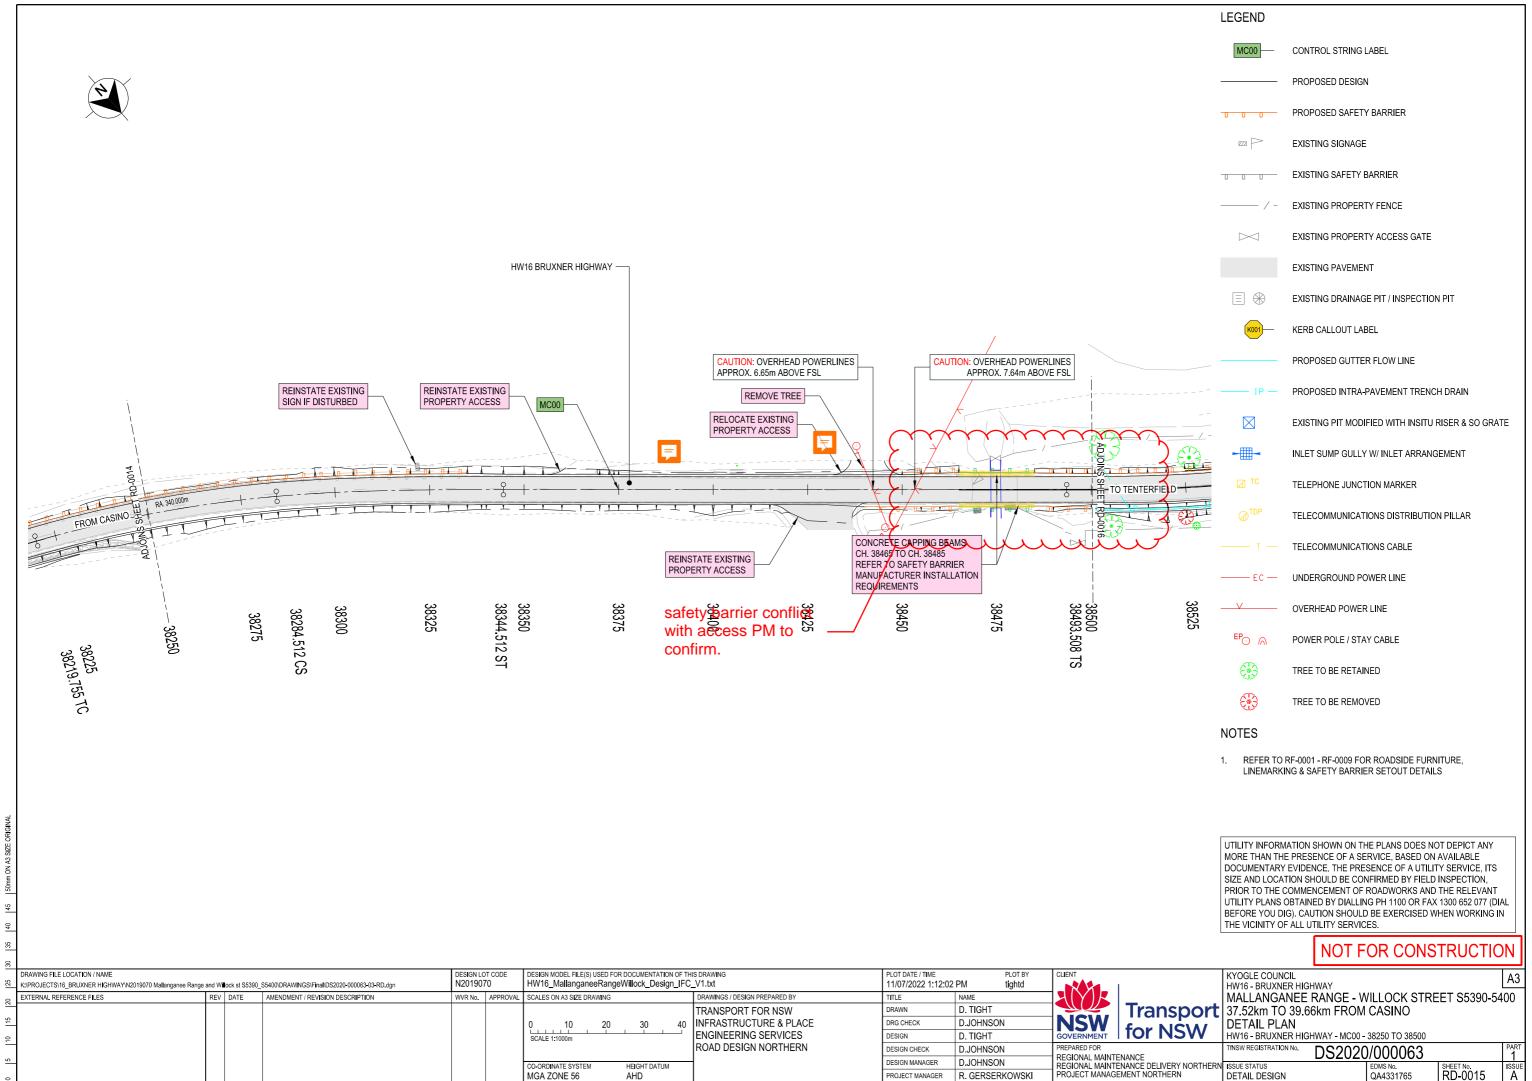


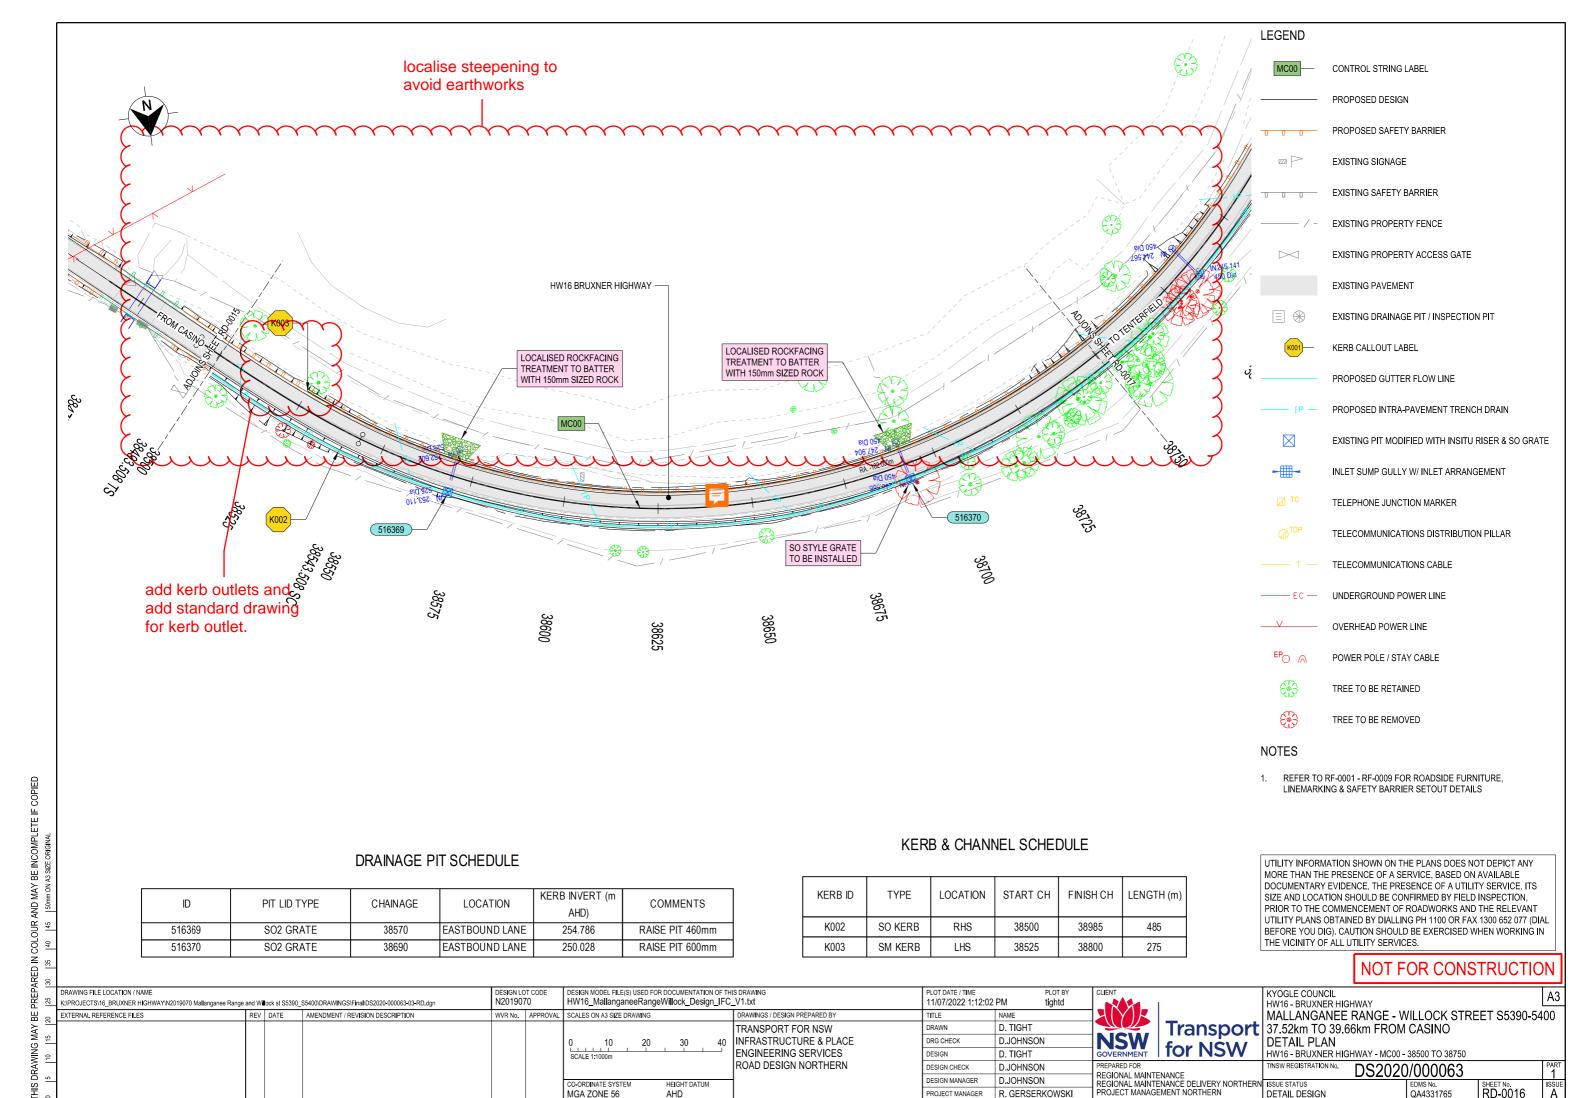

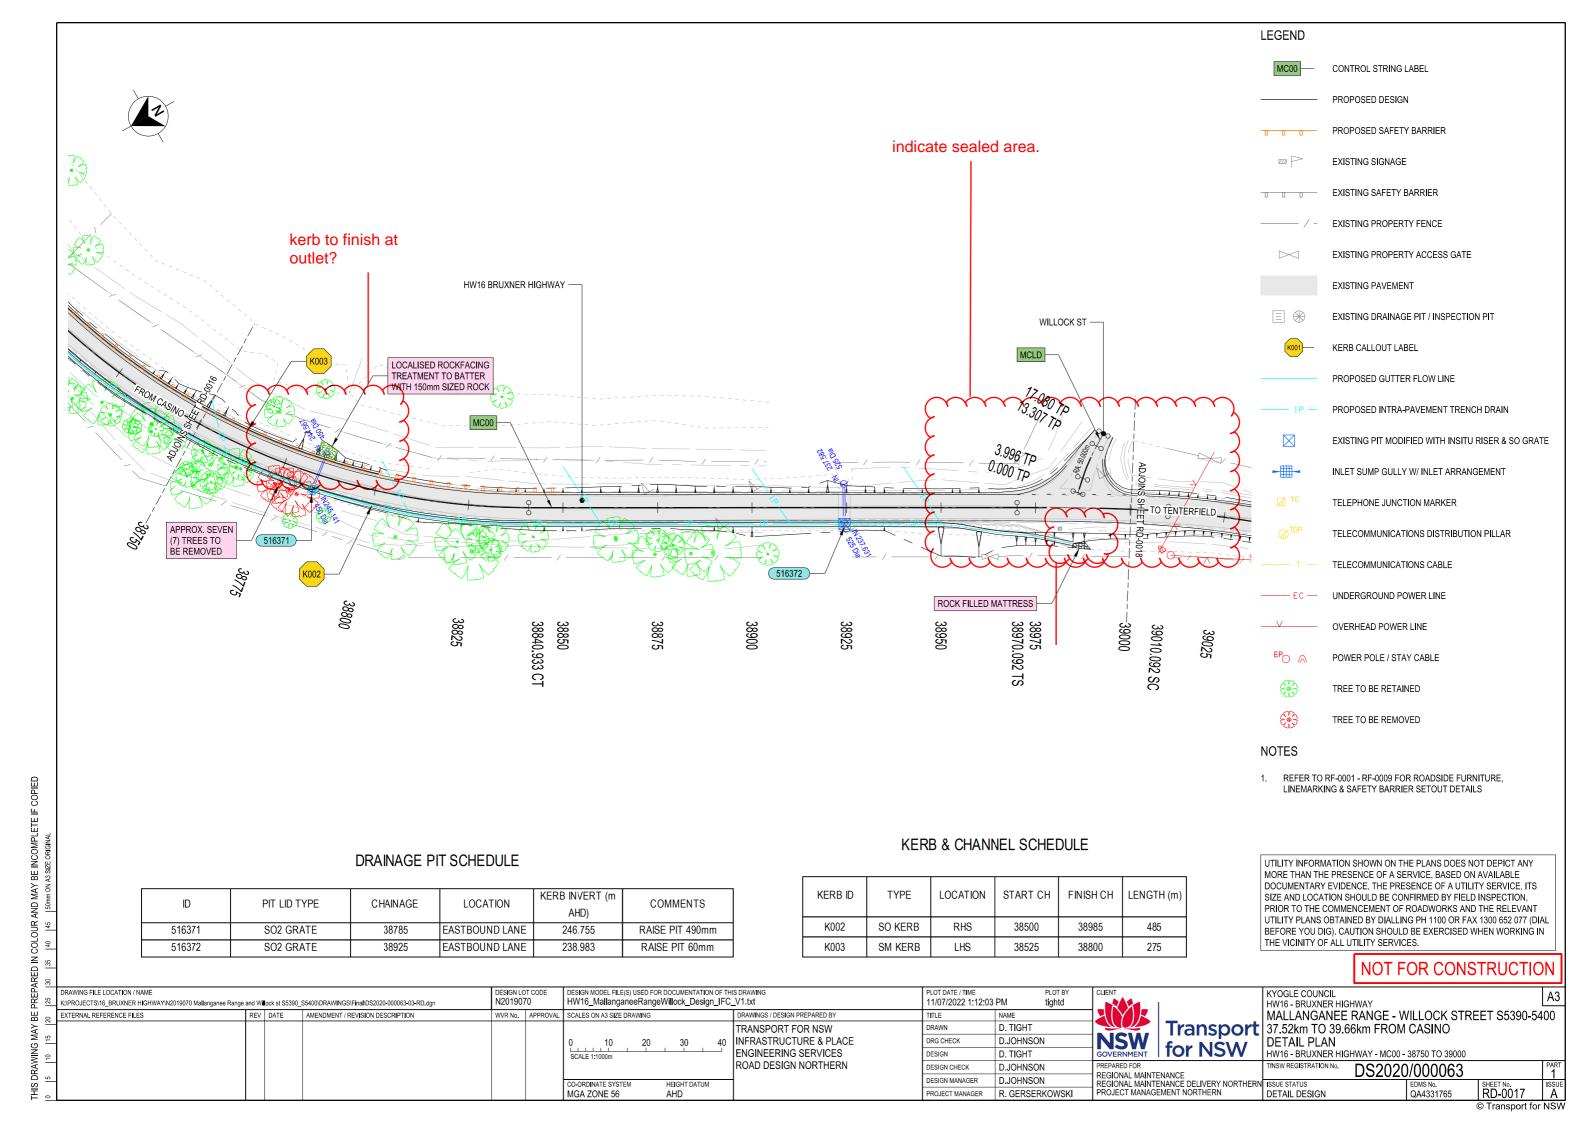


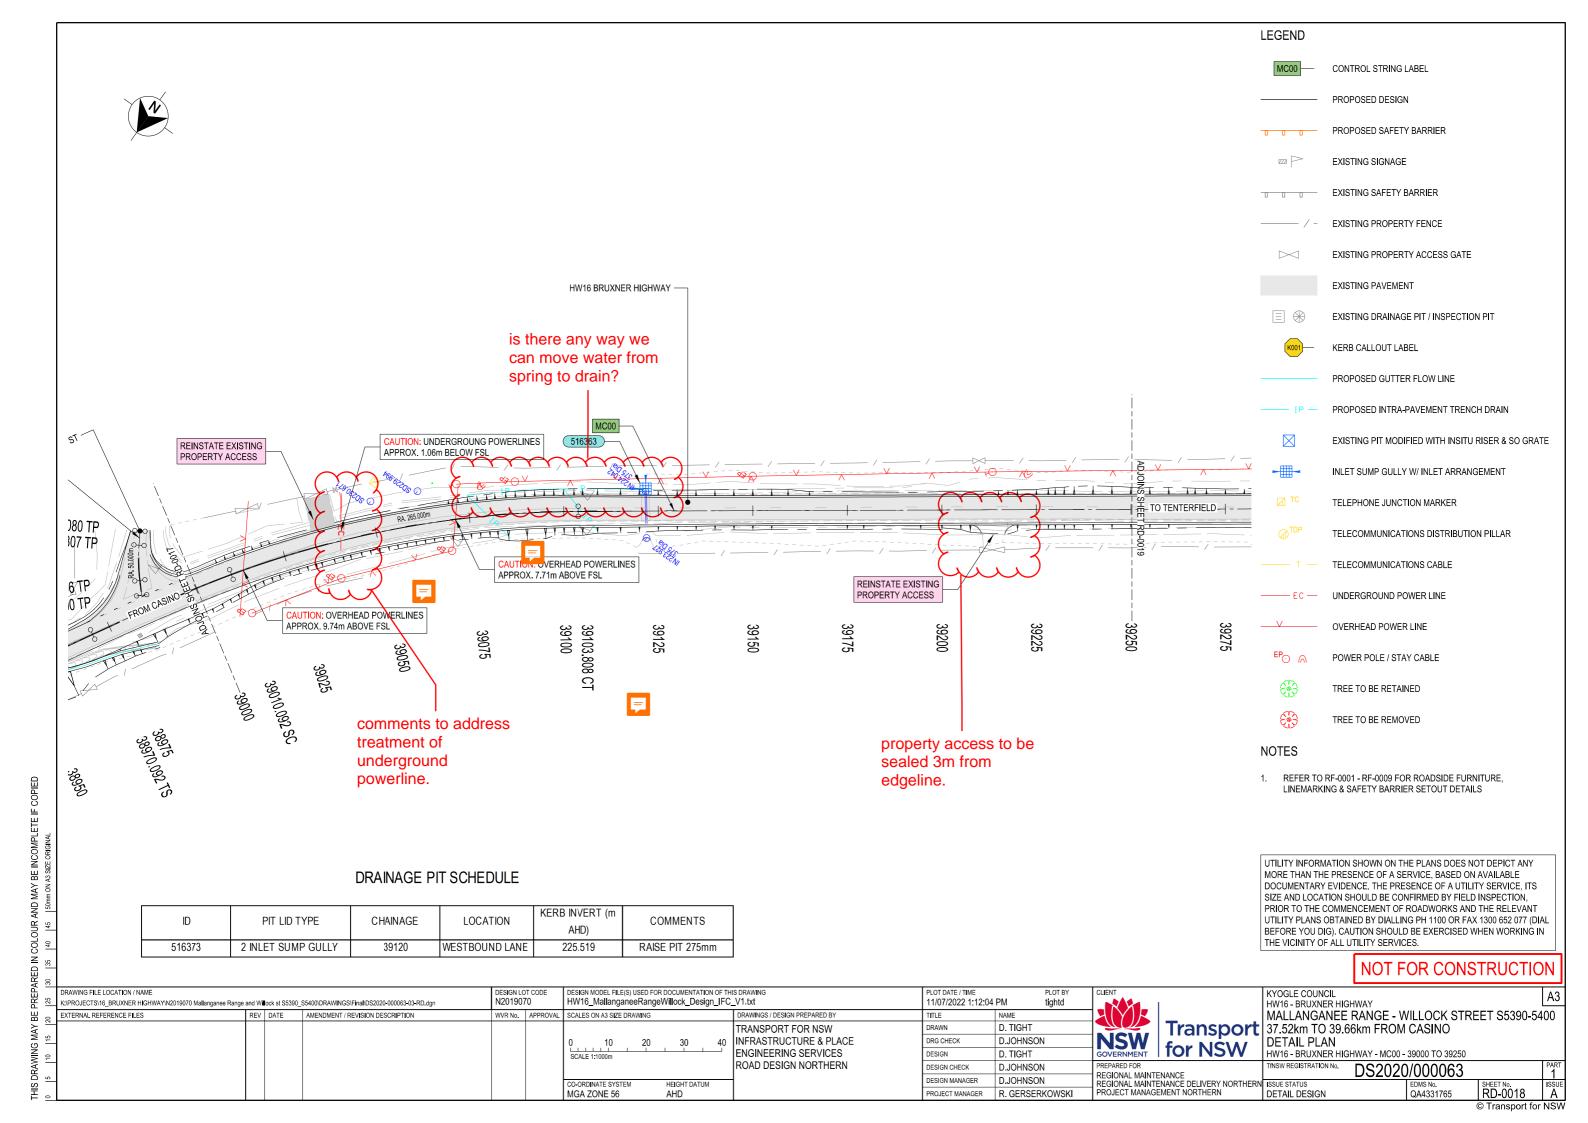

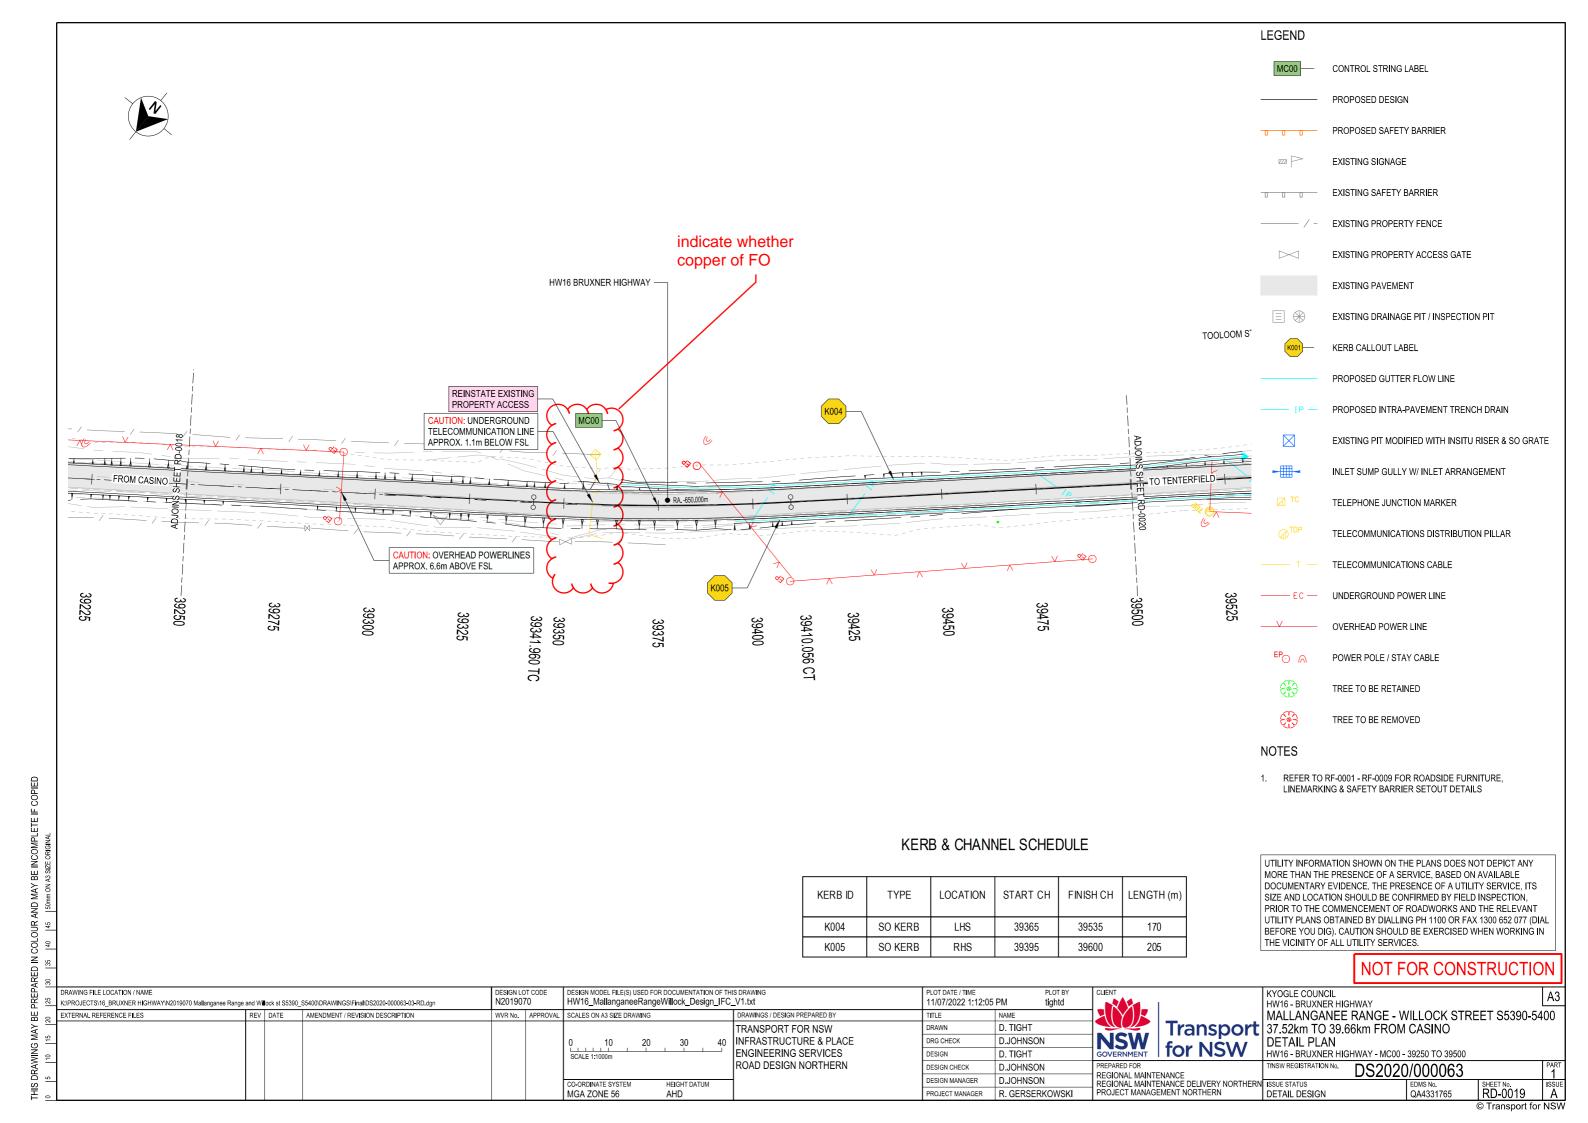


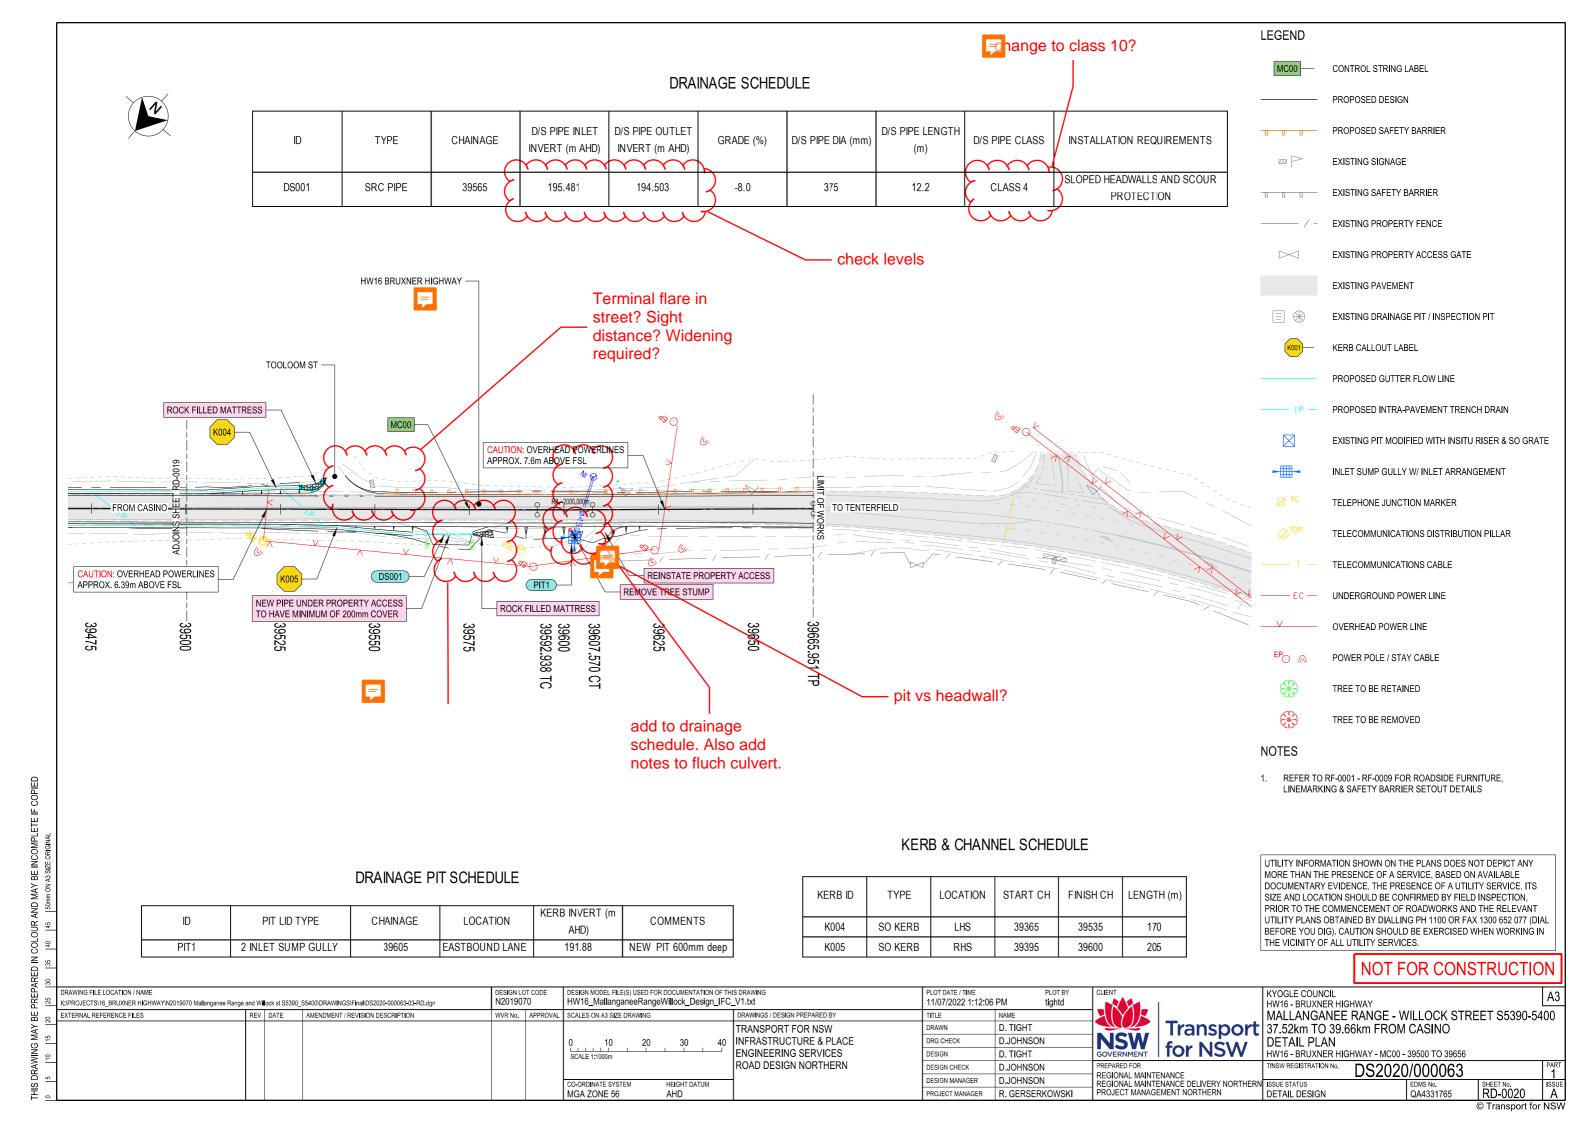


₩ %																	
읍 _	DRAWING FILE LOCATION / NAME				DESIGN LO		DESIGN MODEL FILE(S) USED FOR D			PLOT DATE / TIME	PLOT BY	CLIENT		KYOGLE COUNCIL			Δ3
R 2	K:\PROJECTS\16_BRUXNER HIGHWAY\N2019070 Mallanganee Range	and Willock s	t S5390_S	S5400\DRAWINGS\Final\DS2020-000063-03-RD.dgn	N201907	0	HW16_MallanganeeRangeW	/illock_Design_IFC_	_V1.txt	11/07/2022 1:12:08	PM tightd			HW16 - BRUXNER HIGH		L	
B 00	EXTERNAL REFERENCE FILES	REV DAT	E	AMENDMENT / REVISION DESCRIPTION	WVR No.	APPROVAL	SCALES ON A3 SIZE DRAWING		DRAWINGS / DESIGN PREPARED BY	TITLE	NAME	AYK	_	MALLANGANEE F	RANGE - WILLOCK STF	REET S5390-54	100
<u>~</u> `							0 10 20	30 40	TRANSPORT FOR NSW	DRAWN	D. TIGHT		Transport	37.52km TO 39.66	Skm FROM CASINO		
Σ ₹							HORIZONTAL SCALE 1:1000m		INFRASTRUCTURE & PLACE	DRG CHECK	D.JOHNSON	NSW		LONGITUDINAL S	SECTION		
Ĭ₽₽							0 2 4		ENGINEERING SERVICES	DESIGN	D. TIGHT	GOVERNMENT			WAY - MC00 - 37519 TO 37750		
<u></u> ₹							VERTICAL SCALE 1:200m		ROAD DESIGN NORTHERN	DESIGN CHECK	D.JOHNSON	PREPARED FOR		TfNSW REGISTRATION No.	DS2020/000063		PART 1
2 5							CO-ORDINATE SYSTEM	HEIGHT DATUM		DESIGN MANAGER	D.JOHNSON	REGIONAL MAINTE	:NANCE ENANCE DELIVERY NORTHERN		EDMS No.	SHEET No.	ISSUE
Ë 。							MGA ZONE 56	AHD		PROJECT MANAGER	R. GERSERKOWSKI			DETAIL DESIGN	QA4331765	SHEET No. RD-0021	Ä
												•				© Transport for	NSW

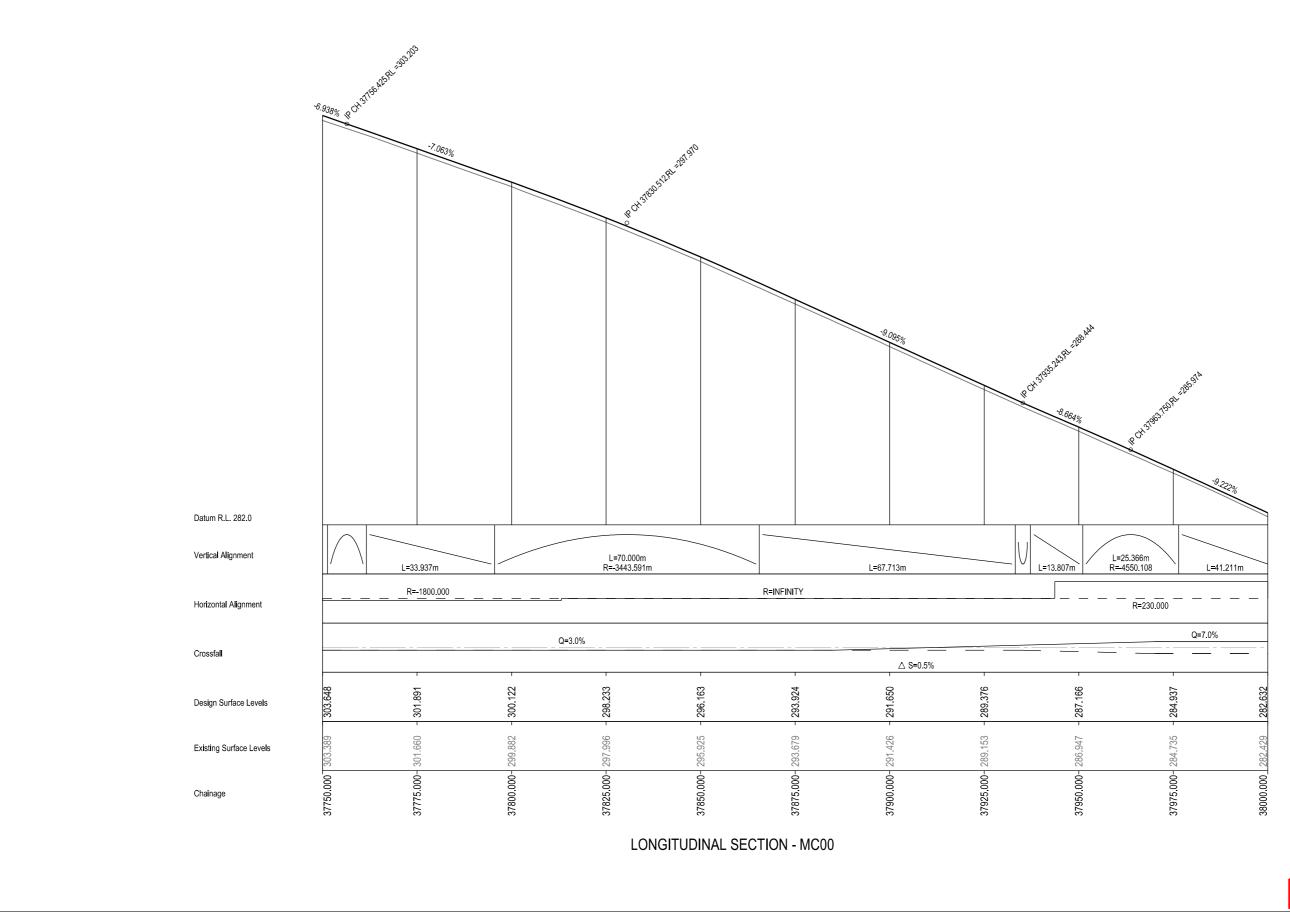

4RE	3												NOTI	011 00110	11100110	
PREP,	DRAWING FILE LOCATION / NAME K:PROJECTS\16_BRUXNER HIGHWAY\N2019070 Mallanganee Range al	ROJECTS\16_BRUXNER HIGHWAYIN2019070 Mallanganee Range and Willock st S5390_S5400IDRAWINGSIFinalIDS2020-000063-03-RD.dgn				DESIGN MODEL FILE(S) USED FOR HW16_MallanganeeRange			PLOT DATE / TIME PLOT BY CLIENT 11/07/2022 1:12:08 PM tightd			I	KYOGLE COUNCIL HW16 - BRUXNER HIGHWAY			A3
BE 02	EXTERNAL REFERENCE FILES	REV	DATE	AMENDMENT / REVISION DESCRIPTION	WVR No. APPROVAL	SCALES ON A3 SIZE DRAWING		DRAWINGS / DESIGN PREPARED BY	TITLE	NAME	JAIYIK		MALLANGANEE RANGE - \		EET S5390-54	00
≱ =	1					0 10 20	30 4	40 TRANSPORT FOR NSW	DRAWN	D. TIGHT		Transport	37.52km TO 39.66km FROM	/I CASINO		
G M	<u> </u>					HORIZONTAL SCALE 1:1000m		INFRASTRUCTURE & PLACE	DRG CHECK	D.JOHNSON	NSW		LONGITUDINAL SECTION			
Š₽₽	2					0 2 4	6	8 ENGINEERING SERVICES	DESIGN	D. TIGHT	GOVERNMENT	for NSW	HW16 - BRUXNER HIGHWAY - MC00	- 37750 TO 38000		
- ₹	7					VERTICAL SCALE 1:200m		ROAD DESIGN NORTHERN	DESIGN CHECK	D.JOHNSON	PREPARED FOR	THANOE	Trinsw registration No. DS202	0/000063		PART 1
S D	⊣					CO-ORDINATE SYSTEM	HEIGHT DATUM	_	DESIGN MANAGER	D.JOHNSON	REGIONAL MAINT	ENANCE ENANCE DELIVERY NORTHERN		EDMS No.	SHEET No.	ISSUE
王。	,					MGA ZONE 56	AHD		PROJECT MANAGER	R. GERSERKOWSKI	PROJECT MANAG	EMENT NORTHERN	DETAIL DESIGN	QA4331765	RD-0022	ιA

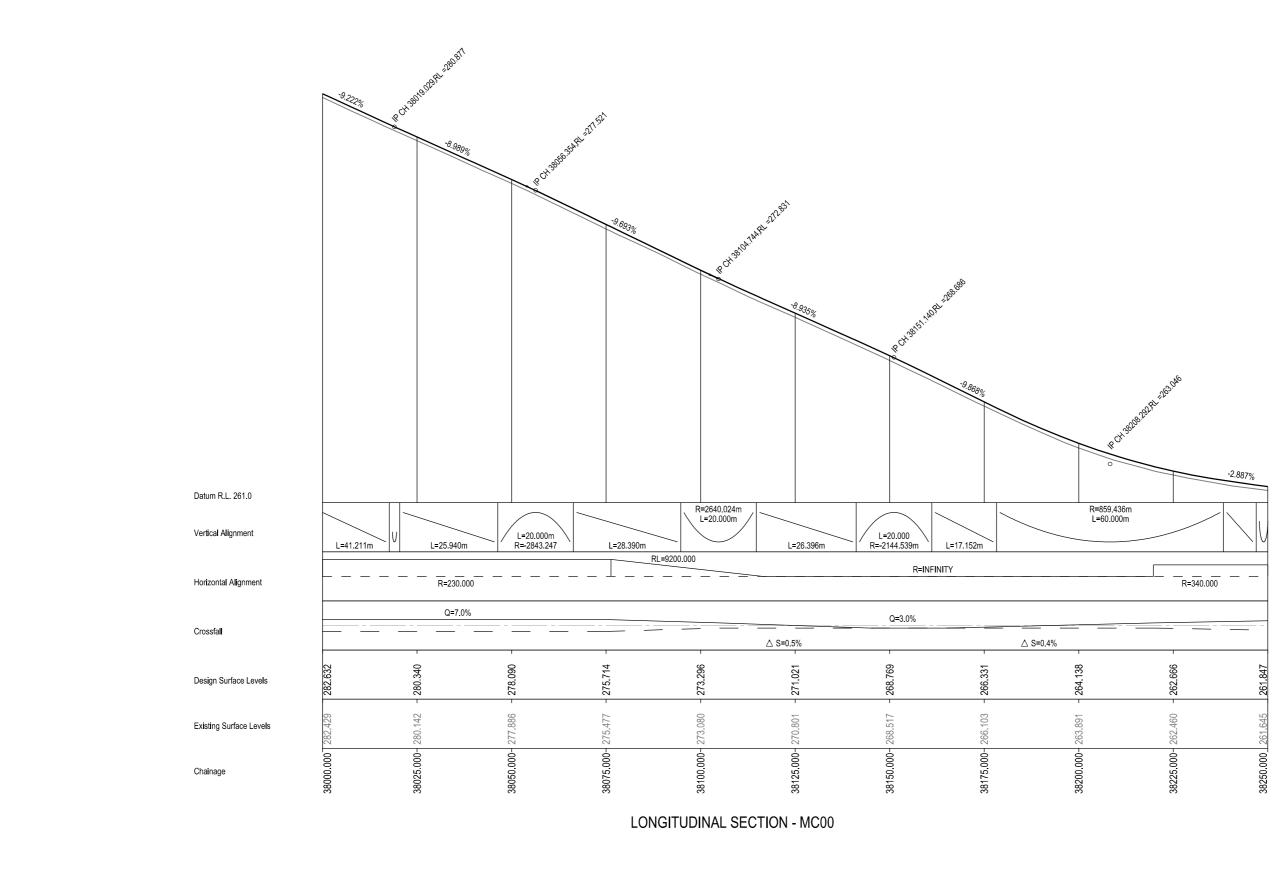


KEI 80													INOT FOR CONC	31100110	// Y
H .	DRAWING FILE LOCATION / NAME			DESIGN LOT C		DESIGN MODEL FILE(S) USED FOR DOCUMENTATION OF THIS		PLOT DATE / TIME	PLOT BY	CLIENT		KYOGLE COUNCIL			Δ3
R ==	K:\PROJECTS\16_BRUXNER HIGHWAY\N2019070 Mallanganee Range	and W a ock st S5390	S5400\DRAWINGS\Final\DS2020-000063-03-RD.dgn	N2019070		HW16_MallanganeeRangeWillock_Design_IFC_	_V1.txt	11/07/2022 1:12:08	PM tightd			HW16 - BRUXNER HIGH		ļ	
BE 02	EXTERNAL REFERENCE FILES	REV DATE	AMENDMENT / REVISION DESCRIPTION	WVR No. A	PPROVAL	SCALES ON A3 SIZE DRAWING	DRAWINGS / DESIGN PREPARED BY	TITLE	NAME	MYK		MALLANGANEE I	RANGE - WILLOCK STR	EET S5390-54	t00
¥ <u>"</u>	1					0 10 20 30 40	TRANSPORT FOR NSW	DRAWN	D. TIGHT		Transport	37.52km TO 39.66	Skm FROM CASINO		
∑ 5 5	1					HORIZONTAL SCALE 1:1000m	INFRASTRUCTURE & PLACE	DRG CHECK	D.JOHNSON	NSW		LONGITUDINAL S	SECTION		
ĕ ₽						0 2 4 6 8	ENGINEERING SERVICES	DESIGN	D. TIGHT	GOVERNMENT			IWAY - MC00 - 38000 TO 38250		
<u></u> ₹ –	1					VERTICAL SCALE 1:200m	ROAD DESIGN NORTHERN	DESIGN CHECK	D.JOHNSON	PREPARED FOR		TfNSW REGISTRATION No.	DS2020/000063		PART
<u>5</u> 5	4					CO-ORDINATE SYSTEM HEIGHT DATUM		DESIGN MANAGER	D.JOHNSON	REGIONAL MAINT	ENANCE ENANCE DEL I VERY NORTHERN		EDMS No.	I SHEET No.	ISSUE
光 。						MGA ZONE 56 AHD		PROJECT MANAGER	R. GERSERKOWSKI			DETAIL DESIGN	QA4331765	RD-0023	Ã
_										•			•	© Transport for	NSW

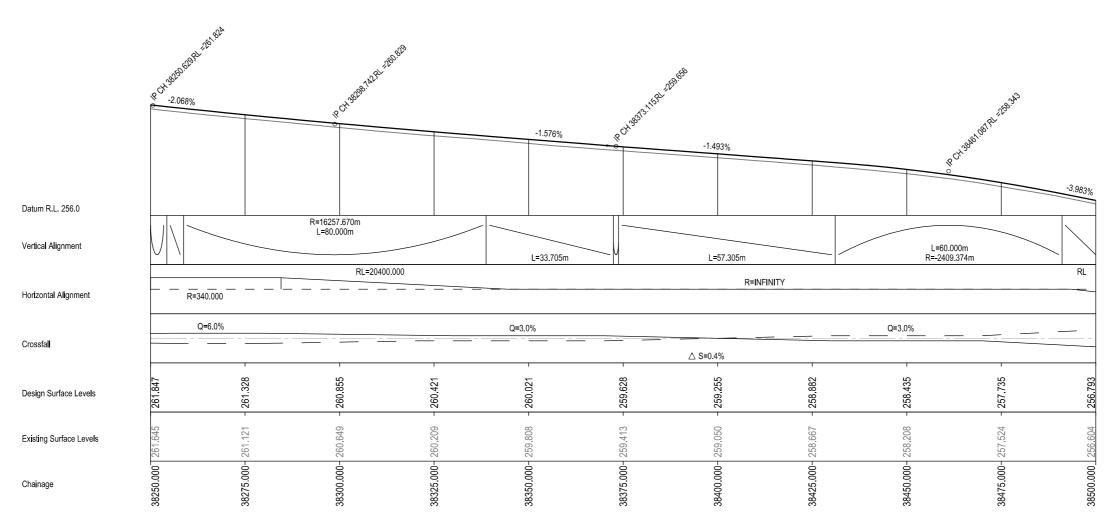

LONGITUDINAL SECTION - MC00


¥ 8									Herr en eene	1110011011
PREP/	DRAWING FILE LOCATION / NAME K:IPROJECTS\16_BRUXNER HIGHWAY\N2019070 Mallanganee Range and Willock st S5390_S5400IDRAWINGS\FinaliDS2020-000063-03-RD.dgn	DESIGN LOT CODE DESIGN MODEL FILE(S) USED FOR DOCUMENTATION OF THIS DRAWING HW16_MallanganeeRangeWillock_Design_IFC_V1.txt			PLOT DATE / TIME 11/07/2022 1:12:09	PLOT BY tightd	CLIENT	KYOGLE COUNCIL HW16 - BRUXNER HIGHWAY		
BE	EXTERNAL REFERENCE FILES REV DATE AMENDMENT / REVISION DESCRIPTION	WVR No.	APPROVAL	SCALES ON A3 SIZE DRAWING	DRAWINGS / DESIGN PREPARED BY	TITLE	NAME		MALLANGANEE RANGE - WILLOCK STRE	ET S5390-5400
¥ ⁻	1			0 10 20 30 40	TRANSPORT FOR NSW	DRAWN	D. TIGHT	Transport	37.52km TO 39.66km FROM CASINO	
() N	4			HORIZONTAL SCALE 1:1000m	INFRASTRUCTURE & PLACE	DRG CHECK	D.JOHNSON		LONGITUDINAL SECTION	
Ž ş				0 2 4 6 8	ENGINEERING SERVICES	DESIGN	D. TIGHT	GOVERNMENT for NSW	HW16 - BRUXNER HIGHWAY - MC00 - 38250 TO 38500	
ΑΣ-	1			VERTICAL SCALE 1:200m	ROAD DESIGN NORTHERN	DESIGN CHECK	D.JOHNSON	PREPARED FOR	THINSW REGISTRATION No. DS2020/000063	PART 1
S =	<u>, </u>			CO-ORDINATE SYSTEM HEIGHT DATUM	-	DESIGN MANAGER	D.JOHNSON	REGIONAL MAINTENANCE REGIONAL MAINTENANCE DELIVERY NORTHERN		SHEET No. ISSUE
Ë	,			MGA ZONE 56 AHD		PROJECT MANAGER	R. GERSERKOWSKI	PROJECT MANAGEMENT NORTHERN	DETAIL DESIGN QA4331765	RD-0024 A
_					-					Transport for NSW

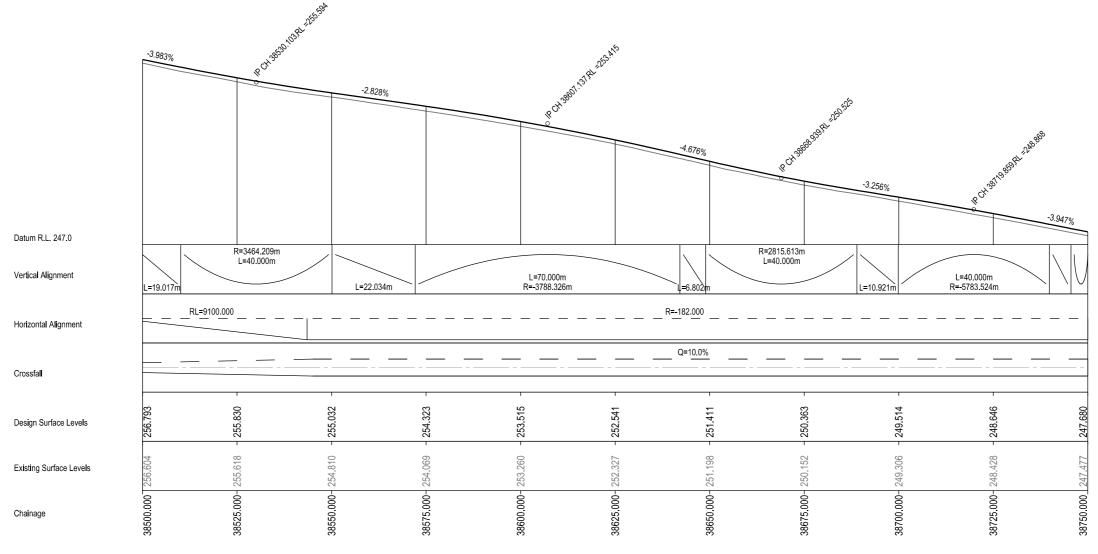


LONGITUDINAL SECTION - MC00

8 8											HOTT ON CONCINCON
щ.,	DRAWING FILE LOCATION / NAME K:PROJECTS\16_BRUXNER HIGHWAY\N2019070 Mallanganee Range and)_S5400\DRAWINGS\Final\DS2020-000063-03-RD.dgn	DESIGN LO N20190		DESIGN MODEL FILE(S) USED FOR DOCUMENTATION OF THE HW16_MallanganeeRangeWillock_Design_IFC	PLOT DATE / TIME 11/07/2022 1:12:09	PLOT BY tightd	CLIENT	KYOGLE COUNCIL HW16 - BRUXNER HIGHWAY		
В 8 П	EXTERNAL REFERENCE FILES RE	EV DATE	AMENDMENT / REVISION DESCRIPTION	WVR No.	APPROVAL	SCALES ON A3 SIZE DRAWING	DRAWINGS / DESIGN PREPARED BY	TITLE	NAME		MALLANGANEE RANGE - WILLOCK STREET S5390-5400
≽ <u>``</u>	1						TRANSPORT FOR NSW	DRAWN	D. TIGHT	Transport	37.52km TO 39.66km FROM CASINO
ລ <u>ເ</u>						HORIZONTAL SCALE 1:1000m	INFRASTRUCTURE & PLACE	DRG CHECK	D.JOHNSON		LONGITUDINAL SECTION
Ž₽						1	ENGINEERING SERVICES	DESIGN	D. TIGHT	GOVERNMENT for NSW	HW16 - BRUXNER HIGHWAY - MC00 - 38500 TO 38750
<u></u> ₹ −	1					VERTICAL SCALE 1:200m	ROAD DESIGN NORTHERN	DESIGN CHECK	D.JOHNSON	PREPARED FOR	TINSW REGISTRATION No. DS2020/000063
 	-					CO-ORDINATE SYSTEM HEIGHT DATUM	-	DESIGN MANAGER	D.JOHNSON	REGIONAL MAINTENANCE REGIONAL MAINTENANCE DELIVERY NORTHER	
Ξ						MGA ZONE 56 AHD		PROJECT MANAGER	R. GERSERKOWSKI	PROJECT MANAGEMENT NORTHERN	ISSUE STATUS EDMS NO. SHEET NO. ISSUE DETAIL DESIGN QA4331765 RD-0025 A

	Ň Ň	5 5	2	5	57	7	5,7	7,	5,		
Chainage	3875.000-	38800.000-38825.000-	38850.000-	38875.000-	38900,000-	38925,000-	38950.000-	38975.000-	39000.000		
AS SKE ORIGINAL			LONGITUDINAL SEC	TION - MC00							
									L	NOT FOR CON	ISTRUCTION
DRAWING FILE LOCATION / NAME K:PROJECTS\(16_BRUXNER HIGHWAY\N2019070 Mailanganee Range and W\)\) k:PROJECTS\(16_BRUXNER HIGHWAY\N2019070 Mailanganee Range and W\)\)	DESIGN LOT CO 100063-03-RD.dgn N2019070	DESIGN MODEL FILE(S) USED FOR DOCUM HW16_MallanganeeRangeWillock	MENTATION OF THIS DRAWING k_Design_IFC_V1.txt		ATE / TIME /2022 1:12:10 PM	PLOT BY t ightd	CLIENT		KYOGLE COUNCIL HW16 - BRUXNER HIGHV	WAY	
EXTERNAL REFERENCE FILES REV DATE AMENDMENT / REVISION DES	CRIPTION WVR No. API	PROVAL SCALES ON A3 SIZE DRAWING	DRAWINGS / DESIGN PREPAR	ED BY TITLE	NAME	-			MALLANGANEE R	ANGE - WILLOCK ST	REET S5390-540
		0 10 20 3	30 40 TRANSPORT FOR N				Tra	ansport	37.52km TO 39.66	km FROM CASINO	
-		HORIZONTAL SCALE 1:1000m	INFRASTRUCTURE 8 6 8 ENGINEERING SER				NSW for	NSW	LONGITUDINAL S		1
		VERTICAL SCALE 1:200m	ROAD DESIGN NOR		D. TIGH		PREPARED FOR	11511		NAY - MC00 - 38750 TO 39000	
					MANAGER D.JOHN		REGIONAL MAINTENANCE	NELIVEDY MODILIEDN	L	DS2020/000063	
		CO-ORDINATE SYSTEM HEIGH MGA ZONE 56 AHD	HT DATUM			RSERKOWSKI	REGIONAL MAINTENANCE D PROJECT MANAGEMENT NO	DRTHERN	DETAIL DESIGN	EDMS No. QA4331765	RD-0026
		•	'	•			•				© Transport for N

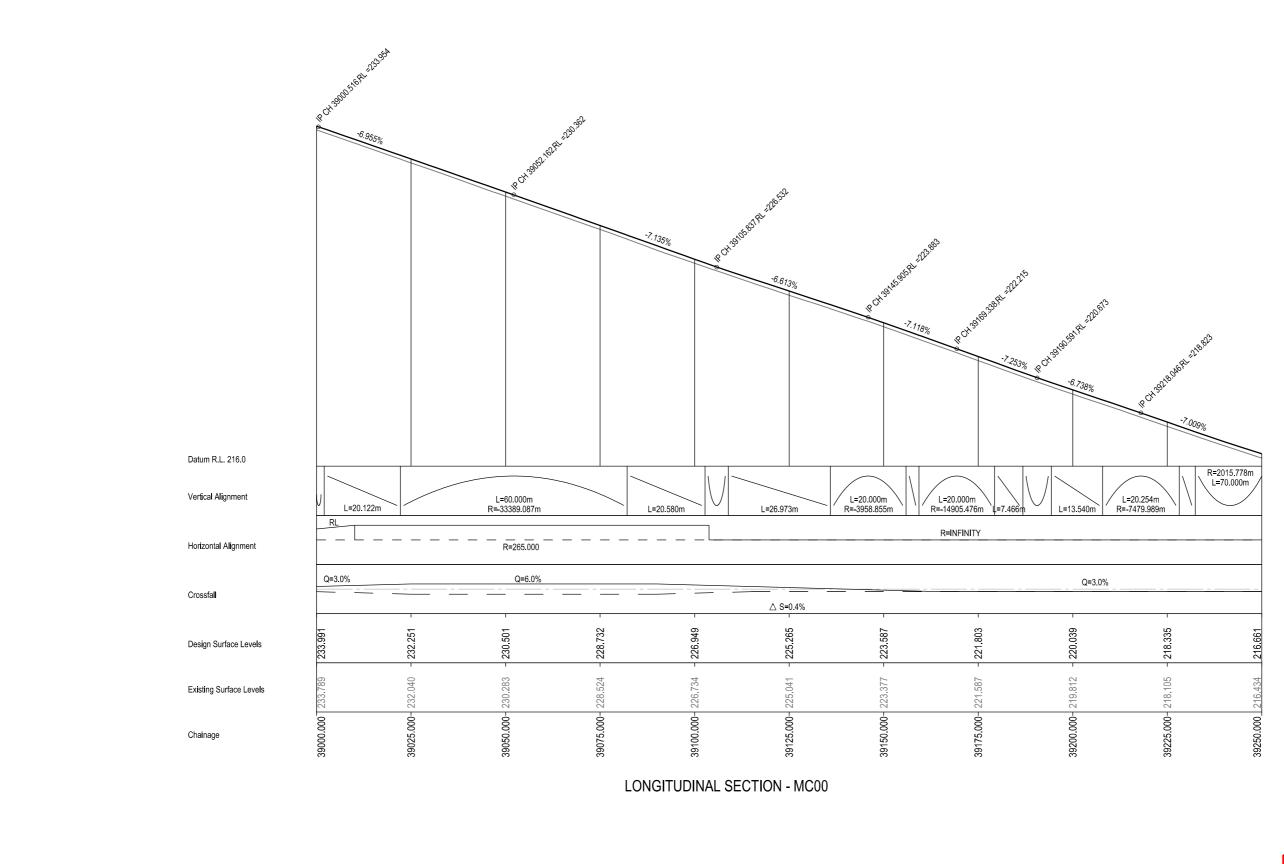

DESIGN MODEL FILE(S) USED FOR DOCUMENTATION OF THIS DRAWING KYOGLE COUNCIL HW16 - BRUXNER HIGHWAY HW16_MallanganeeRangeWillock_Design_IFC_V1.txt 11/07/2022 1:12:10 PM K:PROJECTS\16_BRUXNER HIGHWAYIN2019070 Mallanganee Range and Walock st S5390_S5400IDRAWINGS\FinalDS2020-000063-03-RD.dgr N2019070 tightd Transport MALLANGANEE RANGE - WILLOCK STREET S5390-5400 37.52km TO 39.66km FROM CASINO REV DATE AMENDMENT / REVISION DESCRIPTION DRAWINGS / DESIGN PREPARED BY EXTERNAL REFERENCE FILES SCALES ON A3 SIZE DRAWING WVR No. APPROVAL TITLE D. TIGHT 10 40 TRANSPORT FOR NSW DRAWN HORIZONTAL SCALE 1:1000m INFRASTRUCTURE & PLACE LONGITUDINAL SECTION
HW16 - BRUXNER HIGHWAY - MC00 - 39000 TO 39250 DRG CHECK D.JOHNSON for NSW 8 ENGINEERING SERVICES D. TIGHT DESIGN ROAD DESIGN NORTHERN DS2020/000063 D.JOHNSON TfNSW REGISTRATION No. REGIONAL MAINTENANCE
REGIONAL MAINTENANCE DELIVERY NORTHERN ISSUE STATUS
PROJECT MANAGEMENT NORTHERN DETAIL DESIGN D.JOHNSON DESIGN MANAGER CO-ORDINATE SYSTEM RD-0027 MGA ZONE 56 PROJECT MANAGER R. GERSERKOWSKI

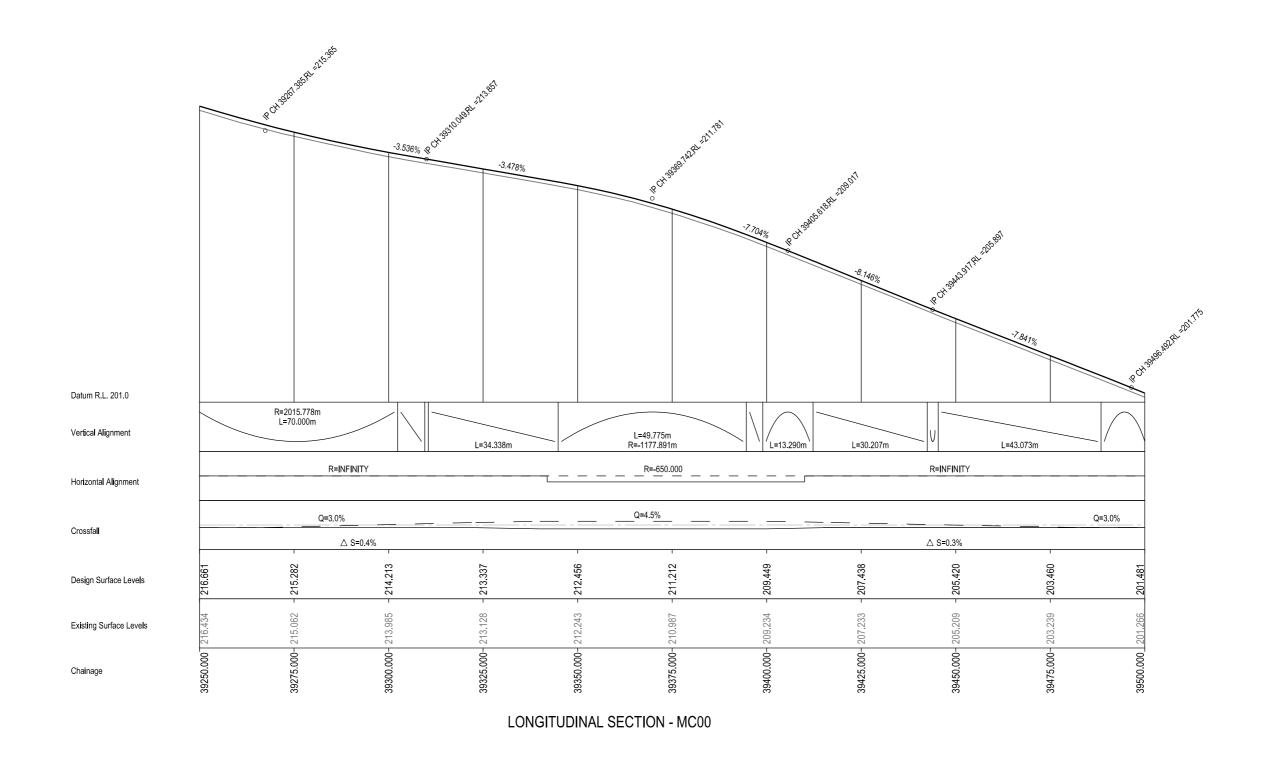

AREI 30													NOTTORCE	NOTIVOCTION	
ш.	DRAWING FILE LOCATION / NAME					OT CODE	DESIGN MODEL FILE(S) USED FOR			PLOT DATE / TIME	PLOT BY	CLIENT	KYOGLE COUNCIL	Δ3	
R ==	K:\PROJECTS\16_BRUXNER HIGHWAY\N2019070 Mallanganee Range and Willock st S5390_S5400\DRAWINGS\Final\DS2020-000063-03-RD.dgn					N2019070 HW16_MallanganeeRangeWillock_Design_IFC_V1.txt				11/07/2022 1:12:10	0 PM tightd		HW16 - BRUXNER HIGHWAY		
BB 02	EXTERNAL REFERENCE FILES	REV	DATE	AMENDMENT / REVISION DESCRIPTION	WVR No.	APPROVAL	SCALES ON A3 SIZE DRAWING		DRAWINGS / DESIGN PREPARED BY	TITLE	NAME		MALLANGANEE RANGE - WILLOCK S	STREET S5390-5400	
≽ <u>"</u>	1						0 10 20	30 40	TRANSPORT FOR NSW	DRAWN	D. TIGHT	Transport	37.52km TO 39.66km FROM CASINO		
∑ ₹	4						HORIZONTAL SCALE 1:1000m		INFRASTRUCTURE & PLACE	DRG CHECK	D.JOHNSON		LONGITUDINAL SECTION		
Ĭ ₽							0 2 4		ENGINEERING SERVICES	DESIGN	D. TIGHT	GOVERNMENT for NSW	HW16 - BRUXNER HIGHWAY - MC00 - 39250 TO 39	500	
≱ —	1						VERTICAL SCALE 1:200m		ROAD DESIGN NORTHERN	DESIGN CHECK	D.JOHNSON	PREPARED FOR	Trinsw registration No. DS2020/00006	33 PART	
□ 5	4						CO-ORDINATE SYSTEM	HEIGHT DATUM		DESIGN MANAGER	D.JOHNSON	REGIONAL MAINTENANCE REGIONAL MAINTENANCE DELIVERY NORTHER			
Ĕ 。							MGA ZONE 56	AHD		PROJECT MANAGER	R. GERSERKOWSKI	PROJECT MANAGEMENT NORTHERN	DETAIL DESIGN QA4331765	RD-0028 A	
							•	'			•	•	· · · · · · · · · · · · · · · · · · ·	© Transport for NSW	



Datum R.L. 188.0

Vertical Alignment

Horizontal Alignment

Design Surface Levels

Existing Surface Levels

Crossfall

Chainage

HW16_MallanganeeRangeWillock_Design_IFC_V1.txt SCALES ON A3 SIZE DRAWING 10 HORIZONTAL SCALE 1:1000m CO-ORDINATE SYSTEM HEIGHT DATUM AHD

MGA ZONE 56

DESIGN MODEL FILE(S) USED FOR DOCUMENTATION OF THIS DRAWING

DRAWINGS / DESIGN PREPARED BY 40 TRANSPORT FOR NSW INFRASTRUCTURE & PLACE 8 ENGINEERING SERVICES ROAD DESIGN NORTHERN

11/07/2022 1:12:11 PM tightd TITLE D. TIGHT DRAWN DRG CHECK D.JOHNSON D. TIGHT DESIGN D.JOHNSON D.JOHNSON DESIGN MANAGER

PROJECT MANAGER R. GERSERKOWSKI

REGIONAL MAINTENANCE
REGIONAL MAINTENANCE DELIVERY NORTHERN ISSUE STATUS
PROJECT MANAGEMENT NORTHERN DETAIL DES

for NSW

NOT FOR CONSTRUCTION KYOGLE COUNCIL HW16 - BRUXNER HIGHWAY

Transport MALLANGANEE RANGE - WILLOCK STREET S5390-5400 37.52km TO 39.66km FROM CASINO

LONGITUDINAL SECTION
HW16 - BRUXNER HIGHWAY - MC00 - 39500 TO 39665

DETAIL DESIGN


DS2020/000063 TfNSW REGISTRATION No.

RD-0029

© Transport for NSW

F R=7349.954m L=20.000m L=52.092m L=70.674m R=INFINITY R=INFINITY Q=3.0% △ S=0.4% 191,427 189,463 39625.000-39650.000-39525,000-39550.000-39575.000-39600,000-

LONGITUDINAL SECTION - MC00

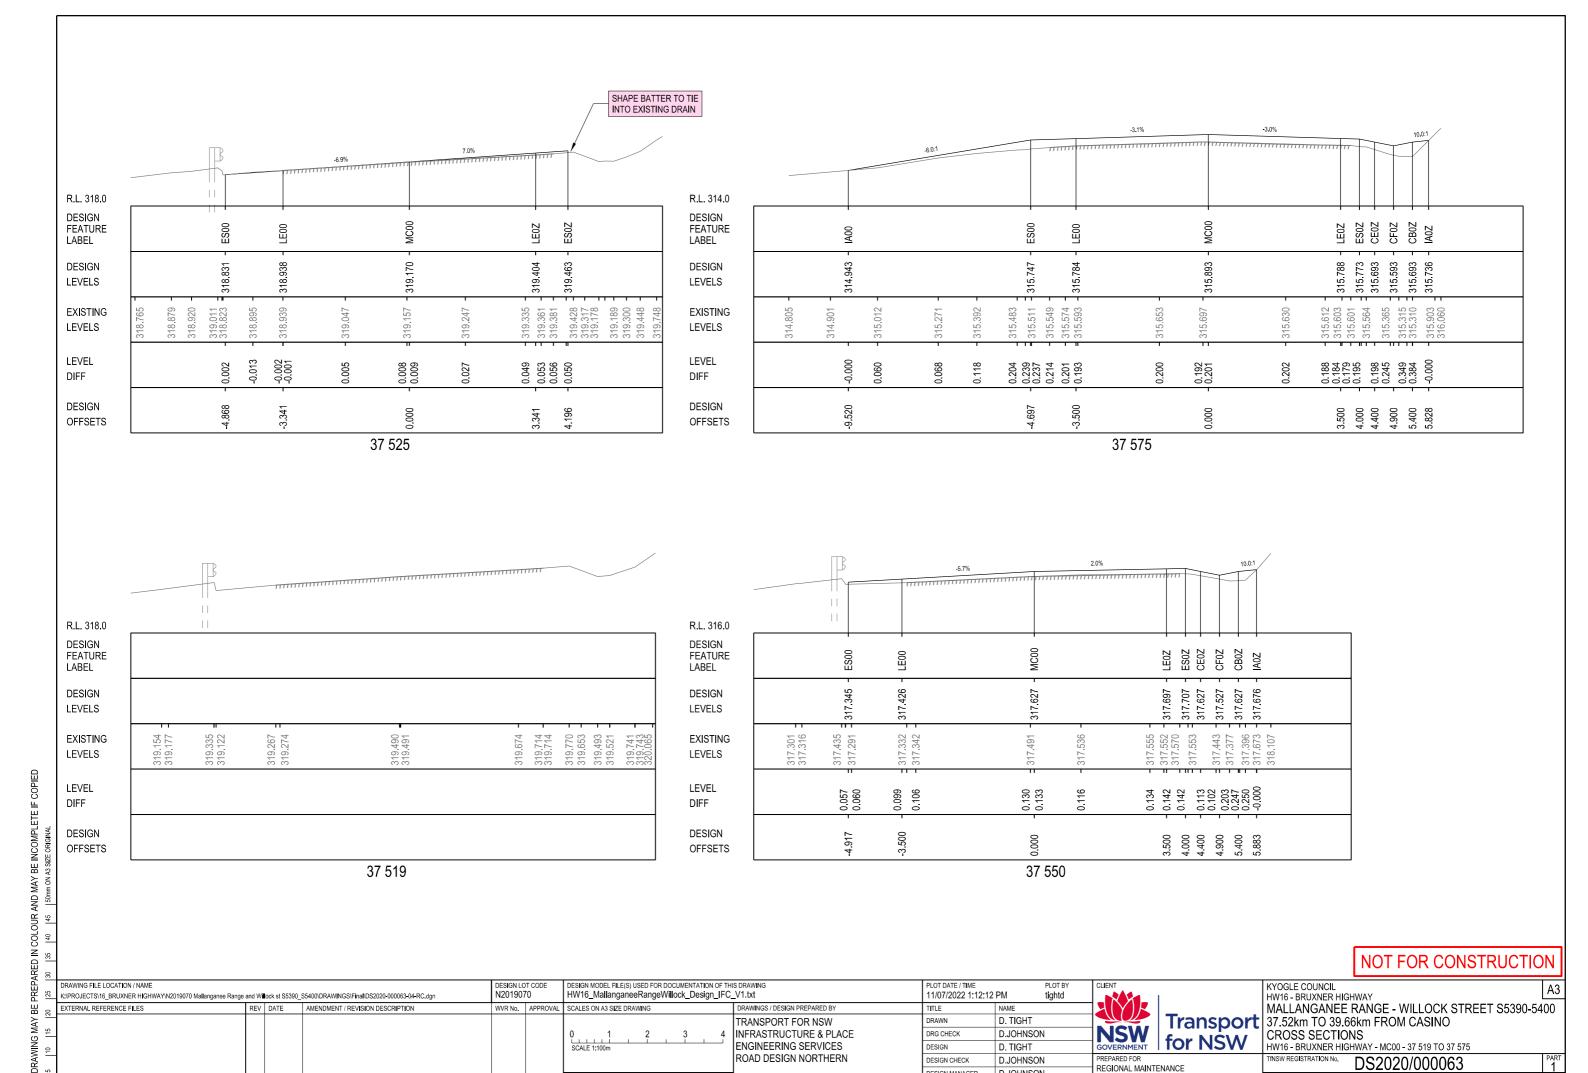

CO-ORDINATE SYSTEM

HEIGHT DATUM

RC-0001 © Transport for NSW

TfNSW REGISTRATION No.

REGIONAL MAINTENANCE
REGIONAL MAINTENANCE DELIVERY NORTHERN ISSUE STATUS


PROJECT MANAGEMENT NORTHERN

D.JOHNSON

D.JOHNSON

R. GERSERKOWSKI

DESIGN MANAGER

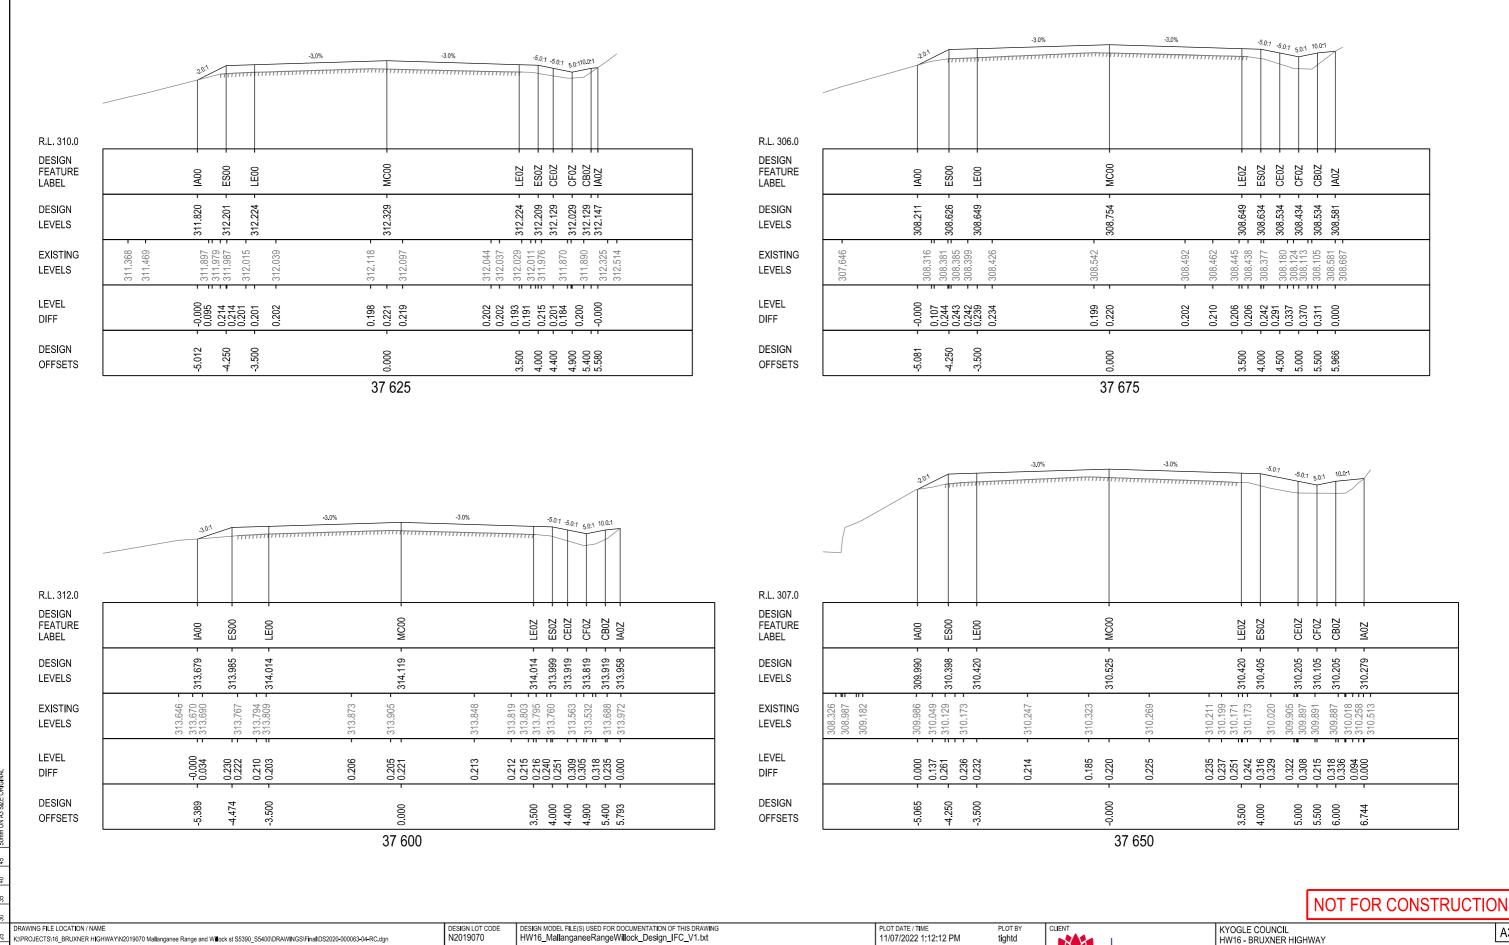

DRAWINGS / DESIGN PREPARED BY

TRANSPORT FOR NSW

ENGINEERING SERVICES

ROAD DESIGN NORTHERN

INFRASTRUCTURE & PLACE

TITLE

DRAWN

DRG CHECK

DESIGN MANAGER

DESIGN

D TIGHT

D. TIGHT

D.JOHNSON

D.JOHNSON

D.JOHNSON

R. GERSERKOWSKI

EXTERNAL REFERENCE FILES

REV DATE AMENDMENT / REVISION DESCRIPTION

WVR No. APPROVAL

SCALES ON A3 SIZE DRAWING

CO-ORDINATE SYSTEM

MGA ZONE 56

HEIGHT DATUM

for NSW

REGIONAL MAINTENANCE


PROJECT MANAGEMENT NORTHERN


Transport MALLANGANEE RANGE - WILLOCK STREET S5390-5400 37.52km TO 39.66km FROM CASINO


CROSS SECTIONS HW16 - BRUXNER HIGHWAY - MC00 - 37 600 TO 37 675 TfNSW REGISTRATION No.


DS2020/000063 REGIONAL MAINTENANCE DELIVERY NORTHERN ISSUE STATUS DETAIL DESIGN

RC-0002

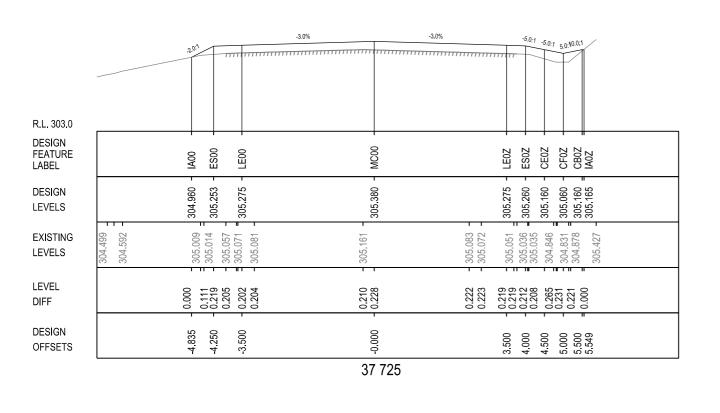

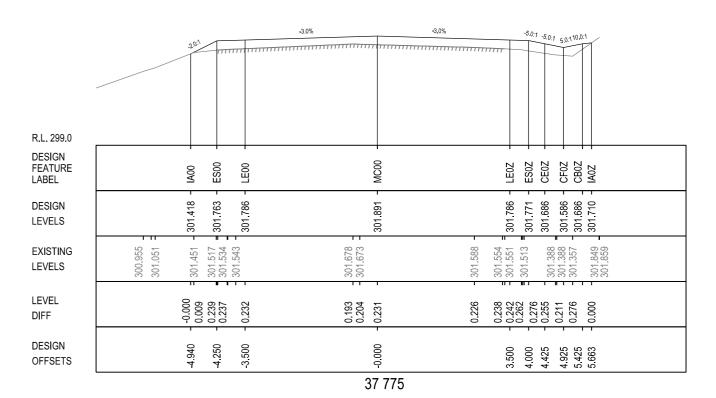


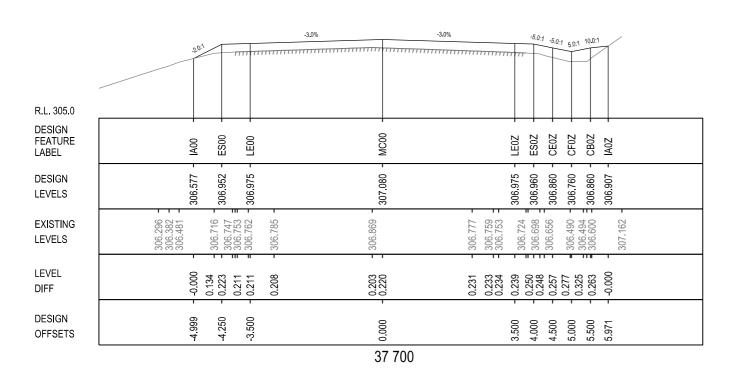

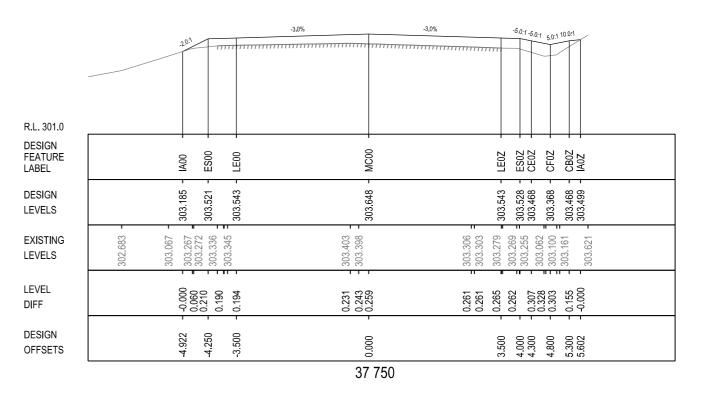

NOT FOR CONCERNICATION

OMPLETE IF COPIE	LEVELS SS	0.134	0 - 0.211 0.208	0.223 - 306.	0.231 - 306.	0.234 0.244 0.255 0.253 0.253	0.000	LEVELS LEVEL DIFF DESIGN	6	220.000 0.060 303. 0.190 303. 0.194 303.	0.231	T 1	0.261 303. 0.261 303. 0.262 303. 0.262 303. 0.363 303.	- 0.000		
∠ ₩ I	OFFSETS	4,999	-3.50	37 700		3.500 4.000 4.500 5.000 5.500		OFFSETS	•	-4.922 -4.250 -3.500	(홍 37 750	3.500 4.000 4.800	OT FOR CON		NC
K:\PROJECTS\16	LOCATION / NAME 6_BRUXNER HIGHWAY\N2019070 Mallanganee Rar ERENCE FILES	`	_S5400IDRAWINGS\FinalDS2020-000063-04-RC. AMENDMENT / REVISION DESCRIPTION	dgn N2	SIGN LOT CODE 2019070 R No. APPROVAL	DESIGN MODEL FILE(S) USED FOR DOC HW16_MallanganeeRangeWillo SCALES ON A3 SIZE DRAWING		_V1.txt DRAWINGS / DESIGN PREPARED BY	PLOT DATE / TIME 11/07/2022 1:12:12 TITLE	NAME	CLIENT		KYOGLE COUNCIL HW16 - BRUXNER HIGHWAY MALLANGANEE RAN	IGE - WILLOCK ST	REET S5390-54	A3 400
AWING MAY						0 1 2 SCALE 1:100m	3 4	TRANSPORT FOR NSW INFRASTRUCTURE & PLACE ENGINEERING SERVICES ROAD DESIGN NORTHERN	DRAWN DRG CHECK DESIGN DESIGN CHECK	D. TIGHT D.JOHNSON D. TIGHT D.JOHNSON		FOR NICIAL	37.52km TO 39.66km CROSS SECTIONS HW16 - BRUXNER HIGHWAY	/ - MC00 - 37 700 TO 37 77		PART
THIS DR						CO-ORDINATE SYSTEM HEI MGA ZONE 56 AH	IGHT DATUM		DESIGN MANAGER PROJECT MANAGER	D.JOHNSON R. GERSERKOWSKI		ANCE ANCE DELIVERY NORTHERN ENT NORTHERN	ISSUE STATUS DETAIL DESIGN	S2020/000063 EDMS No. QA4331765	SHEET No. RC-0003	ISSUE A

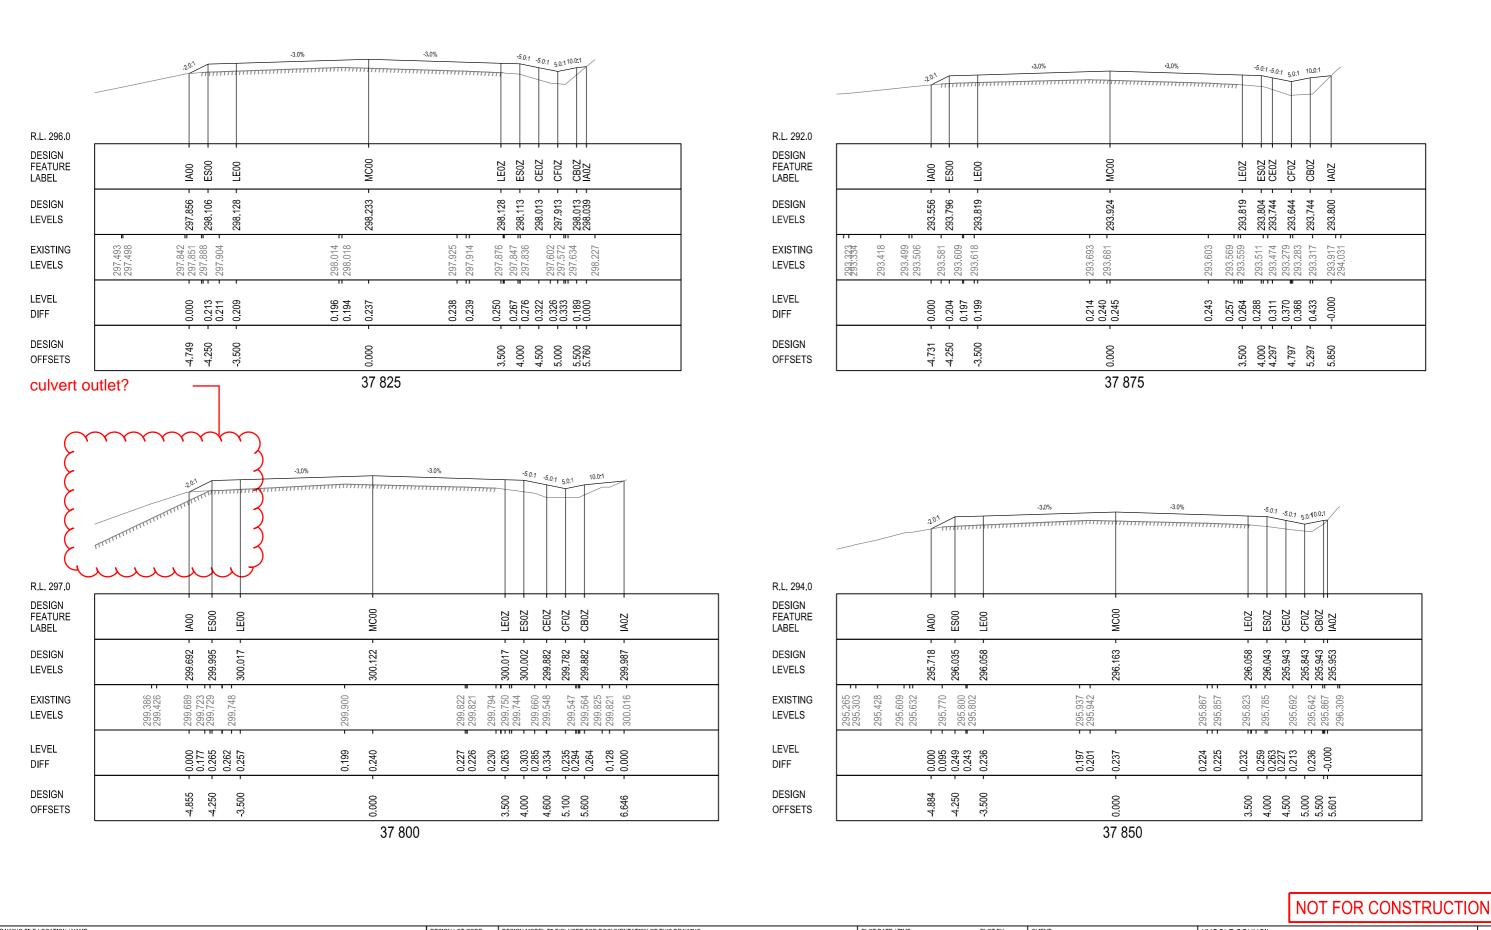

DRAWINGS / DESIGN PREPARED BY

TRANSPORT FOR NSW

INFRASTRUCTURE & PLACE

ENGINEERING SERVICES

ROAD DESIGN NORTHERN

EXTERNAL REFERENCE FILES

CIPROJECTS\16_BRUXNER HIGHWAY\N2019070 Mailanganee Range and W≣ock st \$5390_S5400\DRAWINGS\Final\DS2020-000063-04-RC.dgr

REV DATE AMENDMENT / REVISION DESCRIPTION

N2019070

WVR No. APPROVAL

HW16_MallanganeeRangeWillock_Design_IFC_V1.txt

HEIGHT DATUM

SCALES ON A3 SIZE DRAWING

CO-ORDINATE SYSTEM

MGA ZONE 56

D. TIGHT

D. TIGHT

D.JOHNSON

D.JOHNSON

D.JOHNSON

R. GERSERKOWSKI

tightd

11/07/2022 1:12:13 PM

TITLE

DRAWN

DESIGN


DRG CHECK


DESIGN MANAGER


for NSW


KYOGLE COUNCIL HW16 - BRUXNER HIGHWAY Transport MALLANGANEE RANGE - WILLOCK STREET S5390-5400 37.52km TO 39.66km FROM CASINO CROSS SECTIONS
HW16 - BRUXNER HIGHWAY - MC00 - 37 800 TO 37 875

DS2020/000063 TfNSW REGISTRATION No. REGIONAL MAINTENANCE
REGIONAL MAINTENANCE DELIVERY NORTHERN ISSUE STATUS
PROJECT MANAGEMENT NORTHERN DETAIL DES RC-0004 DETAIL DESIGN

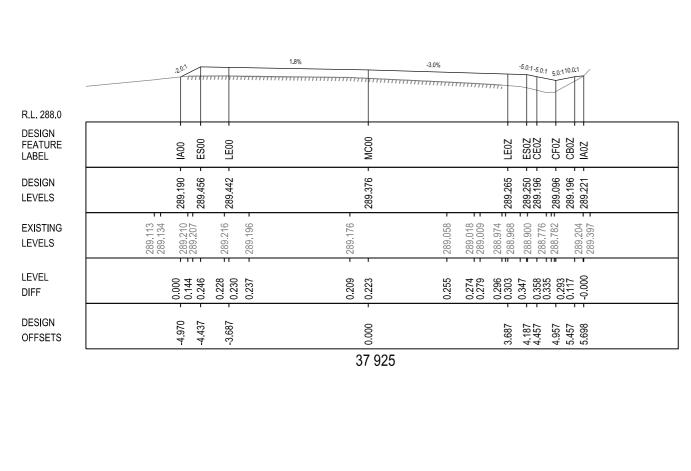


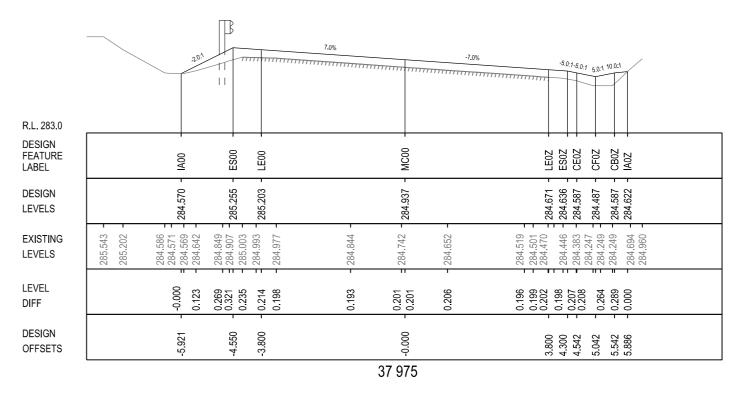


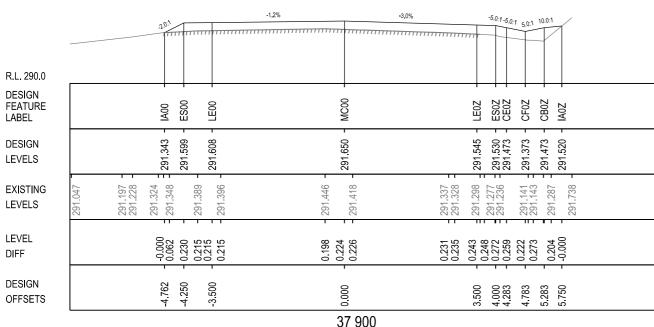

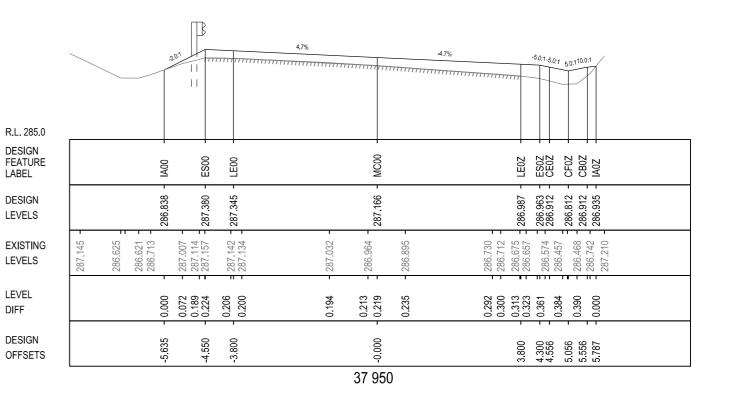

RAWING FILE LOCATION / NAME :PROJECTS'16_BRUXNER HIGHW XTERNAL REFERENCE FILES	VAY\N2019070 Mallanganee Range and Willock st S539	0_S5400/DRAWINGS/Final/DS2020-000063-04-RC.dgn AMENDMENT / REVISION DESCRIPTION		FILE(S) USED FOR DOCUMENTATION OF THIS DRAWING nganeeRangeWillock_Design_IFC_V1.txt IZE DRAWING DRAWINGS / DESIGN PREPARED B TRANSPORT FOR NSW		PLOT BY CLIEN BY TIGHT OF THE PLOT BY TIGHT		NOT FOR CONSTR KYOGLE COUNCIL HW16 - BRUXNER HIGHWAY MALLANGANEE RANGE - WILLOCK STREET 37.52km TO 39.66km FROM CASINO
:\PROJECTS\16_BRUXNER HIGHW	<u>_</u>		N2019070 HW16_Mallar	nganeeRangeWillock_Design_IFC_V1.txt	11/07/2022 1:12:13	3 PM tightd		KYOGLE COUNCIL HW16 - BRUXNER HIGHWAY
								NOT FOR CONOTR
		37 900					37 950	
DESIGN OFFSETS	4.762	00000	3.500 4.000 4.283 4.783	DESIGN OFFSET	1 22	.3.800	0.000	3.800 4.556 5.056 5.787
DIFF	-0.000 0.062 0.230 0.215	0.198	0.231 0.243 0.272 0.259	0.204 JID PIER LINE LINE LINE LINE LINE LINE LINE LINE	0.000	0.200	0.194	0.292 0.300 0.313 0.323 0.384 0.390
LEVEL				l l				

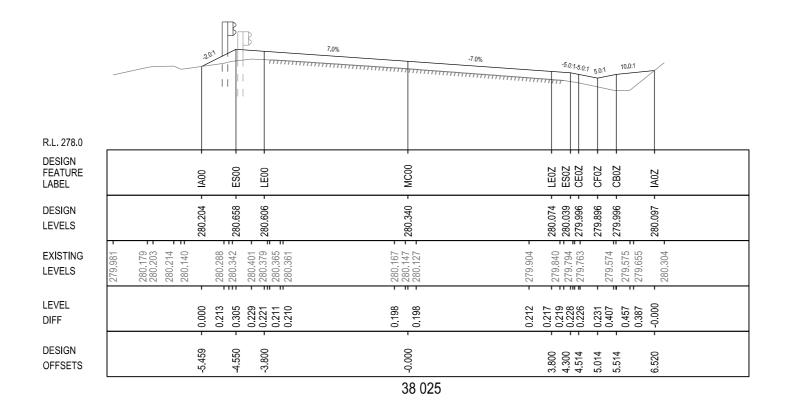


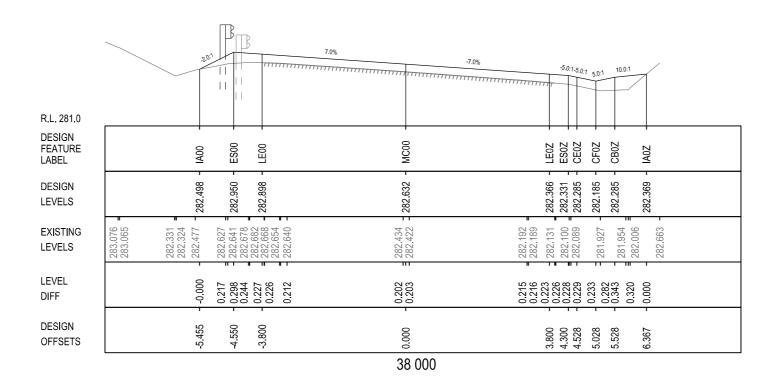

8 [∞]						
<u>.</u>	DRAWING FILE LOCATION / NAME			PLOT DATE / TIME PLOT BY	CLIENT	KYOGLE COUNCIL A3
R 52	K:\PROJECTS\16_BRUXNER HIGHWAY\N2019070 Mallanganee Range and W∎ock st S5390_S5400\DRA	RAWINGS\Final\DS2020-000063-04-RC.dgn N2019070	HW16_MallanganeeRangeWillock_Design_IFC_V1.txt	11/07/2022 1:12:14 PM tightd		HW16 - BRUXNER HIGHWAY
H 0	EXTERNAL REFERENCE FILES REV DATE AMENDM	MENT / REVISION DESCRIPTION WVR No. APPROVAL	SCALES ON A3 SIZE DRAWING DRAWINGS / DESIGN PREPARED BY	TITLE NAME		MALLANGANEE RANGE - WILLOCK STREET S5390-5400
≽ ≃			TRANSPORT FOR NSW	DRAWN D. TIGHT	Transport	37.52km TO 39.66km FROM CASINO
Σ ₹			0 1 2 3 4 INFRASTRUCTURE & PLACE	DRG CHECK D.JOHNSON	I C (A)	CROSS SECTIONS
ĭ.			SCALE 1:100m ENGINEERING SERVICES	DESIGN D. TIGHT	GOVERNMENT for NSW	HW16 - BRUXNER HIGHWAY - MC00 - 38 000 TO 38 025
₹ <u>-</u>	-		ROAD DESIGN NORTHERN	DESIGN CHECK D.JOHNSON	PREPARED FOR	TINSW REGISTRATION No. DS2020/000063
님	_			DESIGN MANAGER D.JOHNSON	REGIONAL MAINTENANCE	
<u>S</u>			CO-ORDINATE STSTEM HEIGHT DATOM	PROJECT MANAGER R GERSERKOWSKI	REGIONAL MAINTENANCE DELIVERY NORTHERN PROJECT MANAGEMENT NORTHERN	SHEET NO. ISSUE DETAIL DESIGN DA4331765 RC-0006 A


THIS DRAWING MAY BE PREPARED IN COLOUR AND MAY BE INCOMPLETE IF COPIED 10 10 110 120 120 120 130 140 145 150mm on A3 SIZE ORIGINAL

RC-0006

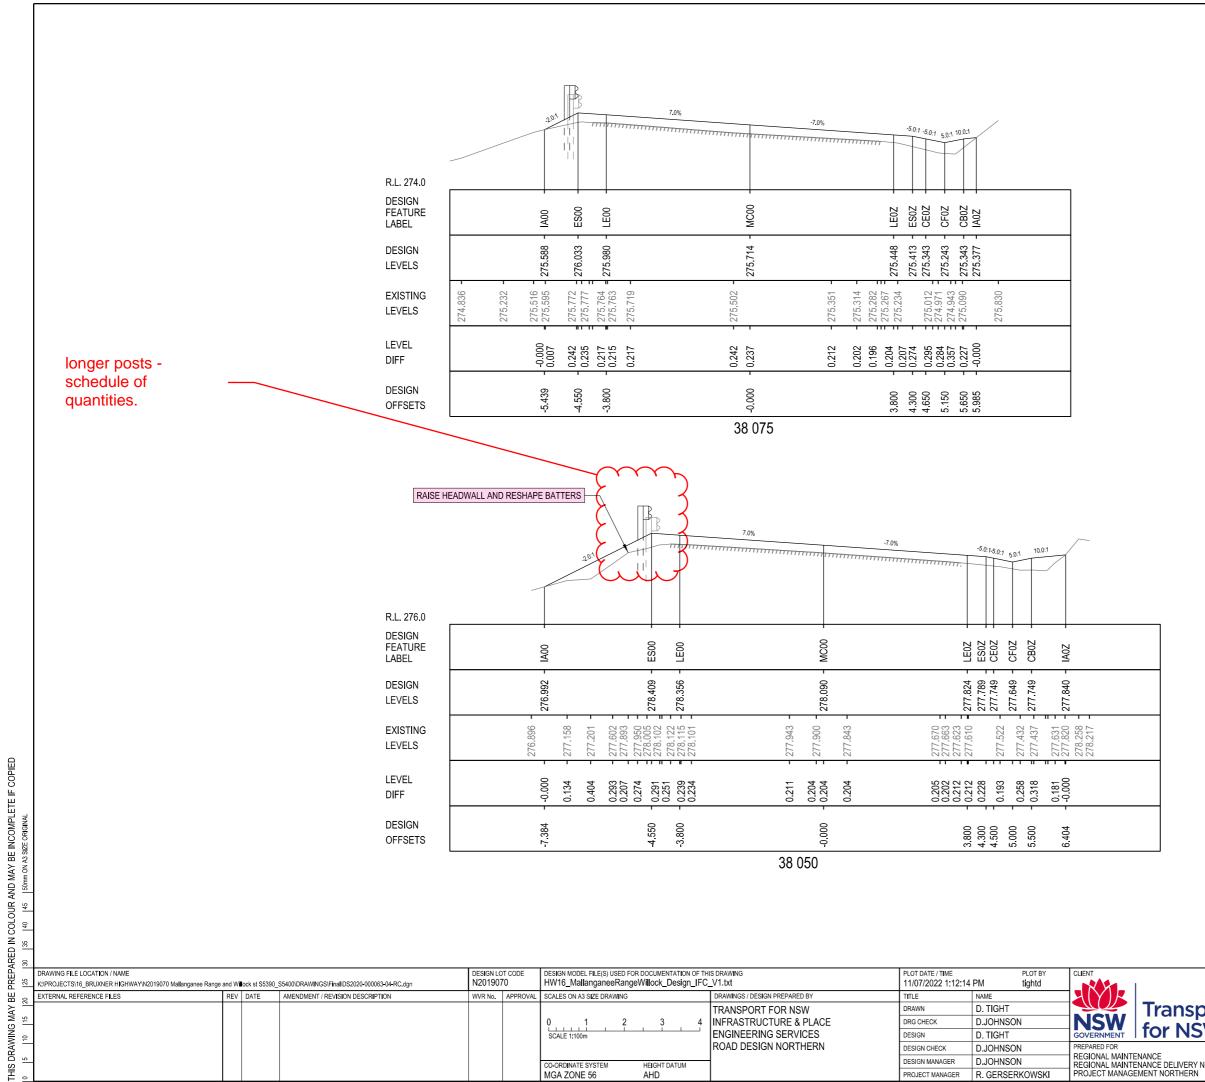


<u>8</u> 8													
П.	DRAWING FILE LOCATION / NAME			DESIGN LOT CO		DESIGN MODEL FILE(S) USED FOR DOCUMENTATION OF TH		PLOT DATE / TIME	PLOT BY	CLIENT		KYOGLE COUNCIL	43
R 25	K:\PROJECTS\16_BRUXNER HIGHWAY\N2019070 Mallanganee Range	and Willock st S	S5390_S5400\DRAWINGS\Final\DS2020-000063-0	RC.dgn N2019070		HW16_MallanganeeRangeWillock_Design_IFC	CV1.txt	11/07/2022 1:12:14	PM tightd			HW16 - BRUXNER HIGHWAY	[7.0]
B o	EXTERNAL REFERENCE FILES	REV DATE	E AMENDMENT / REVISION DESCRIPTION	WVR No. AP	PPROVAL	SCALES ON A3 SIZE DRAWING	DRAWINGS / DESIGN PREPARED BY	TITLE	NAME			MALLANGANEE RANGE - WILLOCK STREE	T S5390-5400
<u>~</u>	1						TRANSPORT FOR NSW	DRAWN	D. TIGHT		Transport	37.52km TO 39.66km FROM CASINO	
S. 5.	_					0 1 2 3 4	INFRASTRUCTURE & PLACE	DRG CHECK	D.JOHNSON	NSW		CROSS SECTIONS	
ĕ ∘						SCALE 1:100m	ENGINEERING SERVICES	DESIGN	D. TIGHT	GOVERNMENT		HW16 - BRUXNER HIGHWAY - MC00 - 38 050 TO 38 075	
₹ `	1						ROAD DESIGN NORTHERN	DESIGN CHECK	D.JOHNSON	PREPARED FOR		THISW REGISTRATION No. DS2020/000063	PART
<u>~</u>	_					OC OPPOSITE OVOTEN LIFEOUT DATING	4	DESIGN MANAGER	D.JOHNSON	REGIONAL MAINTE			1
£						CO-ORDINATE SYSTEM HEIGHT DATUM MGA ZONE 56 AHD			B CEBSEBROWSKI	PROJECT MANAGE	ENANCE DELIVERY NORTHERN EMENT NORTHERN		SHEET No. ISSUE

RC-0007 © Transport for NSW

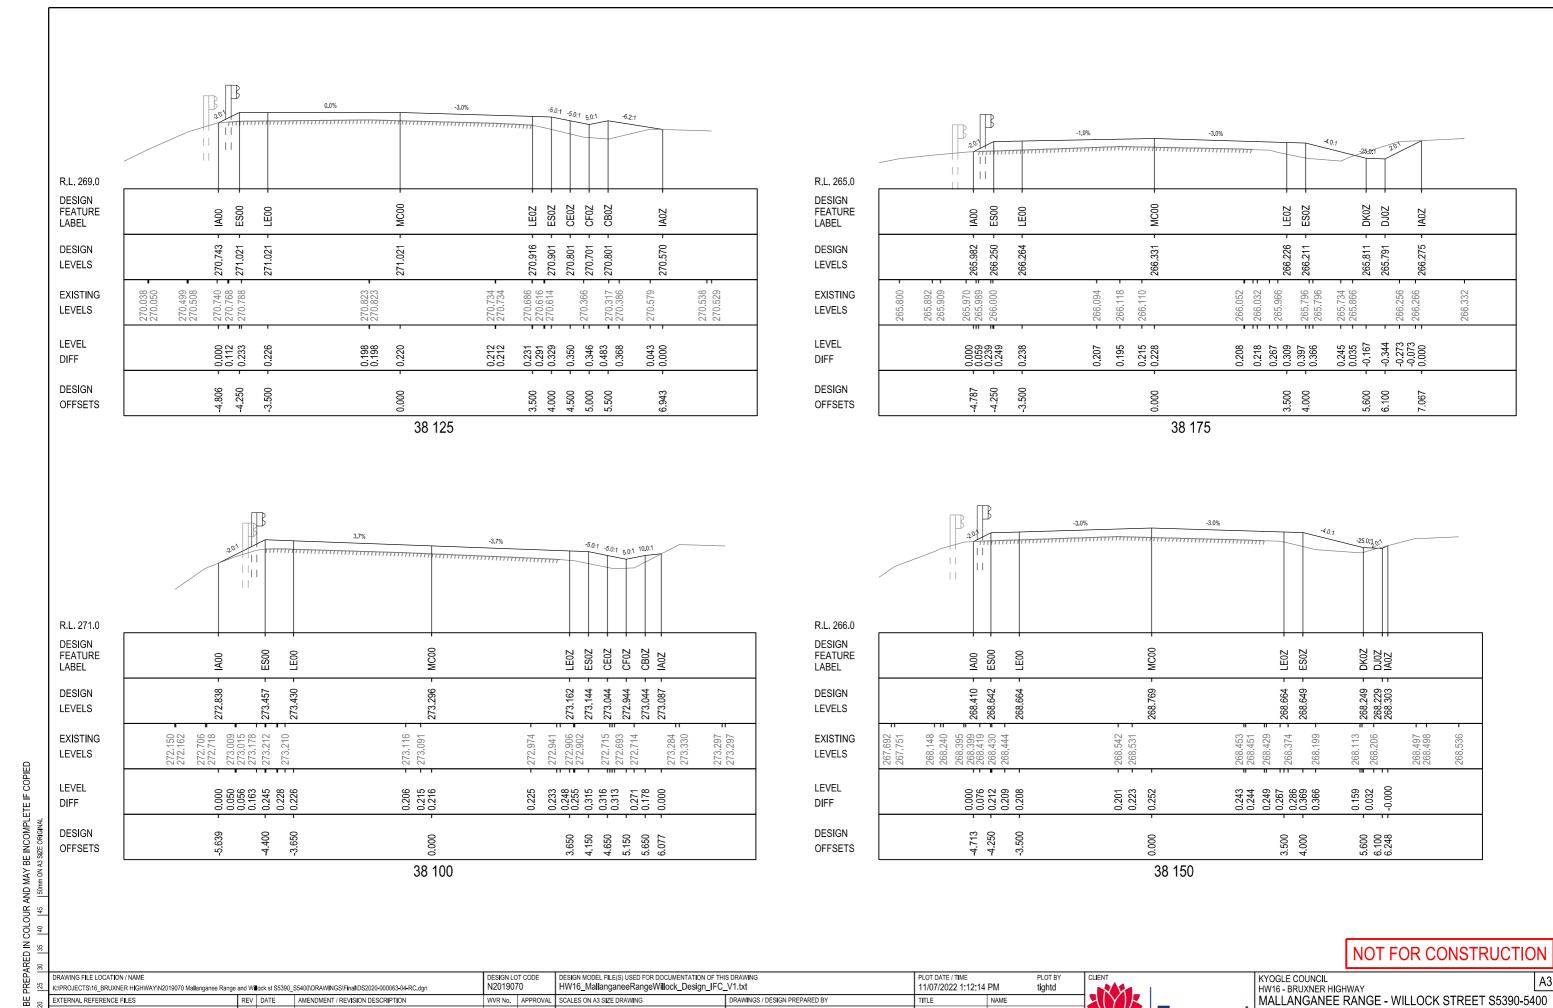

ÄR 30											L'	NOT FOR CON	3111001101	
EP/	DRAWING FILE LOCATION / NAME			DESIGN L		DESIGN MODEL FILE(S) USED FOR DOCUMENTATION OF TH		PLOT DATE / TIME	PLOT BY	CLIENT	KYOGLE COUNCIL			Δ3
R -25	K:\PROJECTS\16_BRUXNER HIGHWAY\N2019070 Mallanganee Range	and W∎ock st S5390	_S5400\DRAWINGS\Final\DS2020-000063-04-RC.dgn	N20190	170	HW16_MallanganeeRangeWillock_Design_IFC	C_V1.txt	11/07/2022 1:12:1	4 PM tightd		HW16 - BRUXNER HIGHWA		L	
B 0:	EXTERNAL REFERENCE FILES	REV DATE	AMENDMENT / REVISION DESCRIPTION	WVR No.	APPROVAL	SCALES ON A3 SIZE DRAWING	DRAWINGS / DESIGN PREPARED BY	TITLE	NAME		MALLANGANEE R/	ANGE - WILLOCK STF	REET S5390-540	ე0
¥ <u>~</u>	7						TRANSPORT FOR NSW	DRAWN	D. TIGHT	Transport	37.52km TO 39.66ki	m FROM CASINO		
S = 25						0 1 2 3 4	INFRASTRUCTURE & PLACE	DRG CHECK	D.JOHNSON		CROSS SECTIONS			
N €							ENGINEERING SERVICES	DESIGN	D. TIGHT	GOVERNMENT for NSW		'AY - MC00 - 38 100 TO 38 125	ز	
≱ –							ROAD DESIGN NORTHERN	DESIGN CHECK	D.JOHNSON	PREPARED FOR	TfNSW REGISTRATION No.)S2020/000063		PART 1
_5 ⊡	4					CO-ORDINATE SYSTEM HEIGHT DATUM	1	DESIGN MANAGER	D.JOHNSON	REGIONAL MAINTENANCE REGIONAL MAINTENANCE DELIVERY NORTHERN		EDMS No.	SHEET No	ISSUE
Ĭ.						MGA ZONE 56 AHD		PROJECT MANAGER	R. GERSERKOWSKI	PROJECT MANAGEMENT NORTHERN	DETAIL DESIGN	QA4331765	RC-0008	Ä
. –	•					•	•	•		•	•	•	© Transport for N	NSW

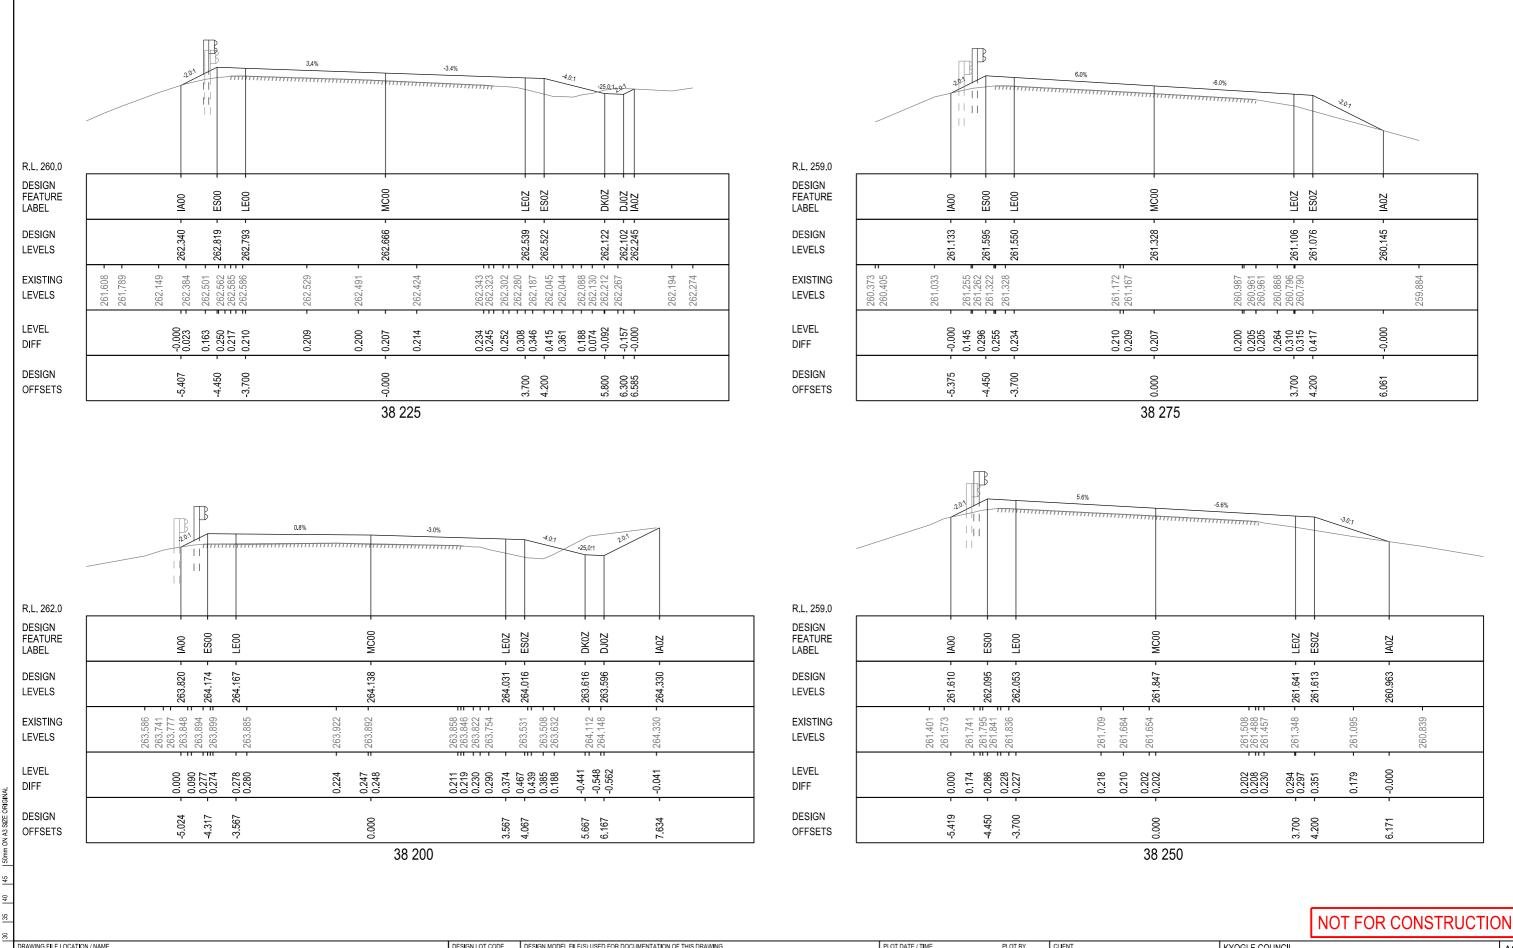

DRAWINGS / DESIGN PREPARED BY SCALES ON A3 SIZE DRAWING TRANSPORT FOR NSW INFRASTRUCTURE & PLACE ENGINEERING SERVICES ROAD DESIGN NORTHERN

HEIGHT DATUM

HW16_MallanganeeRangeWillock_Design_IFC_V1.txt

CO-ORDINATE SYSTEM

MGA ZONE 56

N2019070

WVR No. APPROVAL

CIPROJECTS\16_BRUXNER HIGHWAY\N2019070 Mailanganee Range and W≣ock st \$5390_S5400\DRAWINGS\Final\DS2020-000063-04-RC.dgr

REV DATE

EXTERNAL REFERENCE FILES

AMENDMENT / REVISION DESCRIPTION

11/07/2022 1:12:15 PM tightd TITLE D. TIGHT DRAWN DRG CHECK D.JOHNSON DESIGN D. TIGHT D.JOHNSON D.JOHNSON DESIGN MANAGER

R. GERSERKOWSKI


PROJECT MANAGEMENT NORTHERN

for NSW

KYOGLE COUNCIL HW16 - BRUXNER HIGHWAY Transport MALLANGANEE RANGE - WILLOCK STREET S5390-5400 37.52km TO 39.66km FROM CASINO

CROSS SECTIONS HW16 - BRUXNER HIGHWAY - MC00 - 38 150 TO 38 200 DS2020/000063 TfNSW REGISTRATION No. REGIONAL MAINTENANCE
REGIONAL MAINTENANCE DELIVERY NORTHERN ISSUE STATUS

RC-0009

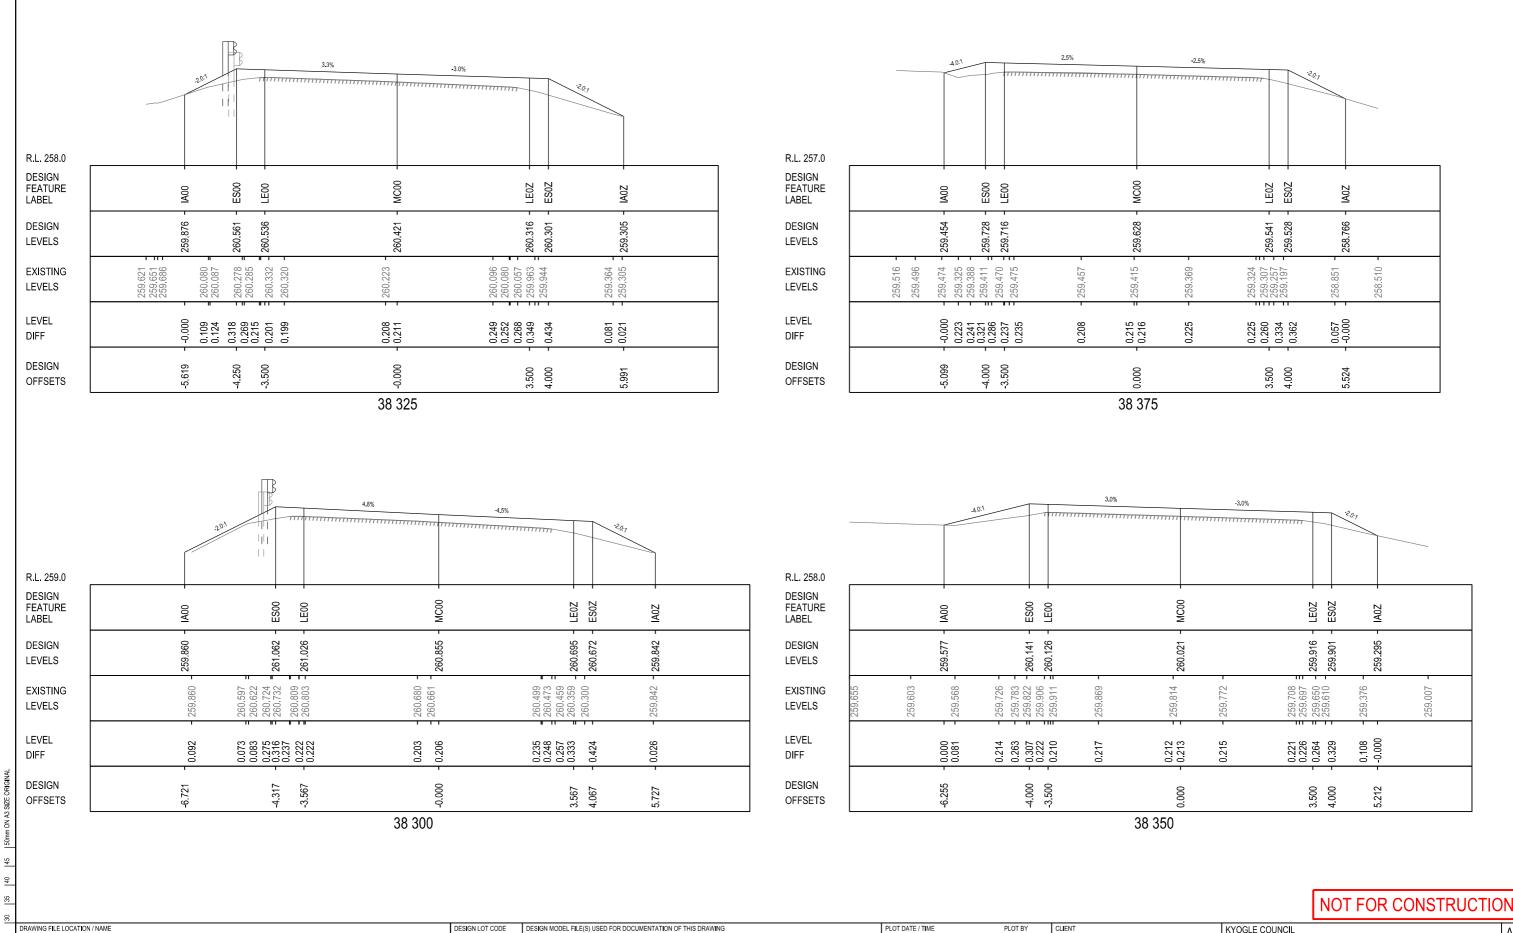

DRAWINGS / DESIGN PREPARED BY

TRANSPORT FOR NSW

ENGINEERING SERVICES

ROAD DESIGN NORTHERN

INFRASTRUCTURE & PLACE

11/07/2022 1:12:15 PM

TITLE

DRAWN

DESIGN

DRG CHECK

DESIGN MANAGER

NAME

D. TIGHT

D. TIGHT

D.JOHNSON

D.JOHNSON

D.JOHNSON

R. GERSERKOWSKI

tightd

REGIONAL MAINTENANCE

PROJECT MANAGEMENT NORTHERN

EXTERNAL REFERENCE FILES

CIPROJECTS\16_BRUXNER HIGHWAY\N2019070 Mailanganee Range and W≣ock st \$5390_S5400\DRAWINGS\Final\DS2020-000063-04-RC.dgr

REV DATE AMENDMENT / REVISION DESCRIPTION

N2019070

WVR No. APPROVAL

HW16_MallanganeeRangeWillock_Design_IFC_V1.txt

HEIGHT DATUM

SCALES ON A3 SIZE DRAWING

CO-ORDINATE SYSTEM

MGA ZONE 56


for NSW


KYOGLE COUNCIL HW16 - BRUXNER HIGHWAY Transport MALLANGANEE RANGE - WILLOCK STREET S5390-5400 37.52km TO 39.66km FROM CASINO

CROSS SECTIONS HW16 - BRUXNER HIGHWAY - MC00 - 38 225 TO 38 250

DS2020/000063 TfNSW REGISTRATION No. REGIONAL MAINTENANCE DELIVERY NORTHERN ISSUE STATUS

RC-0010

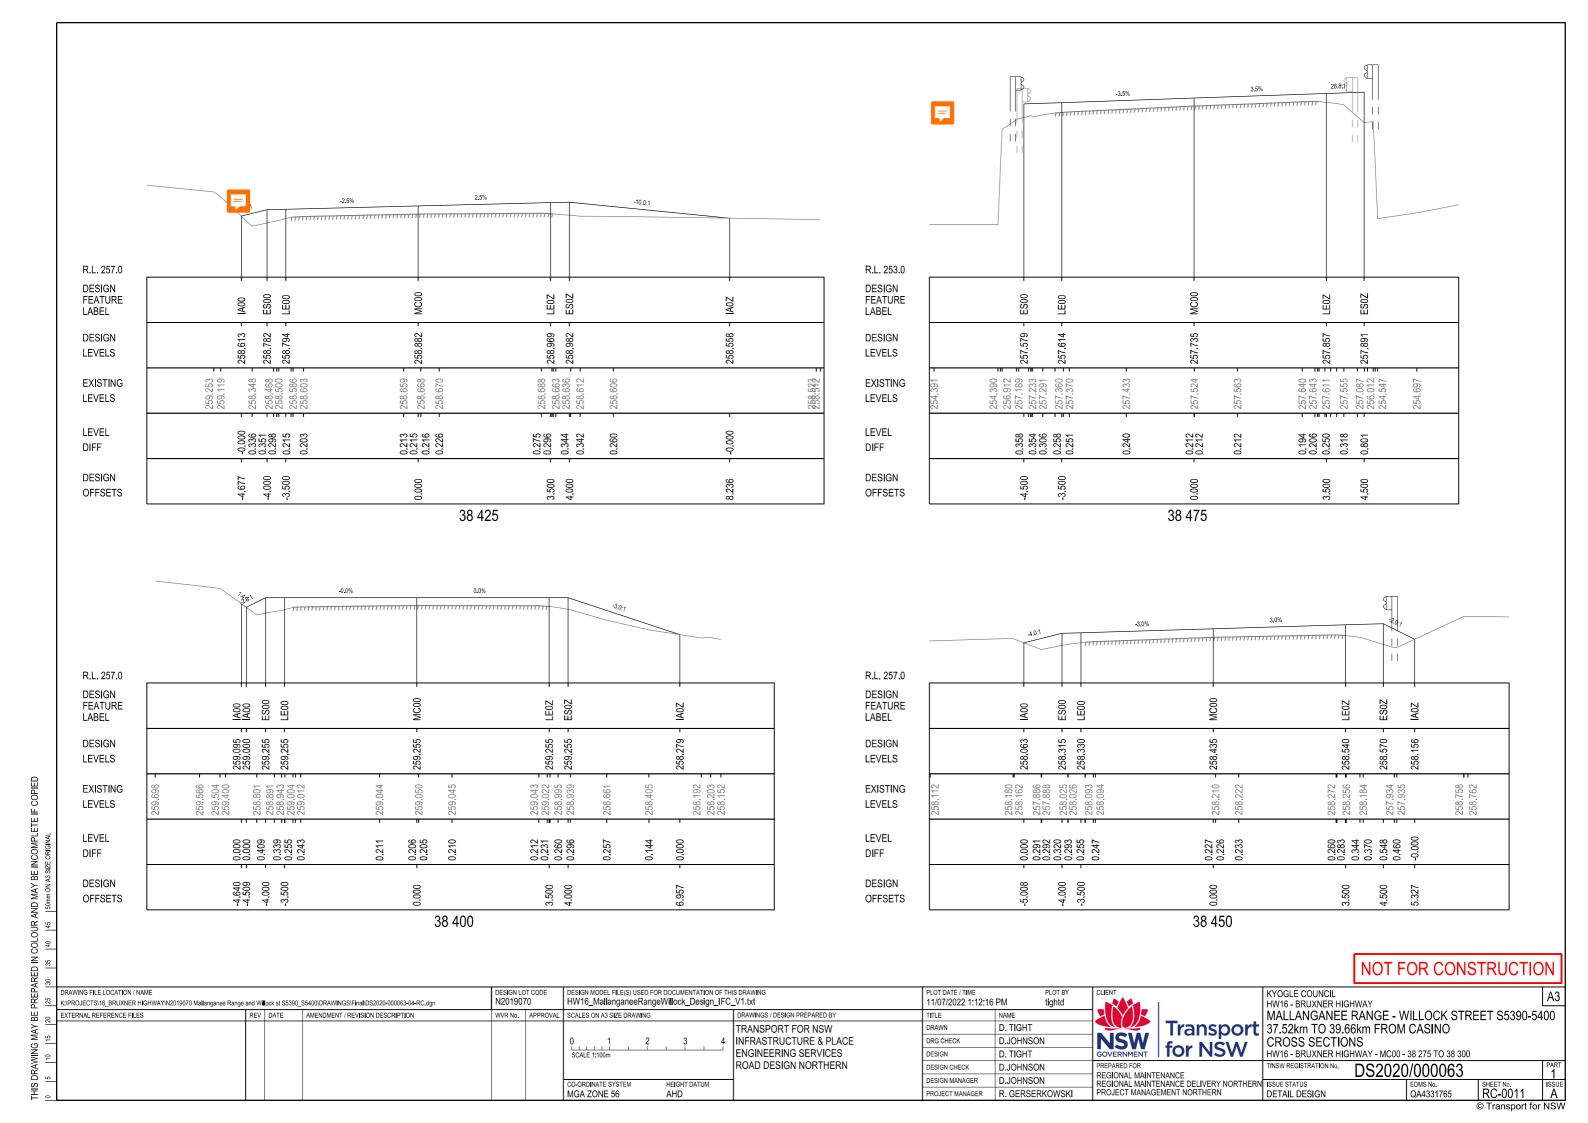

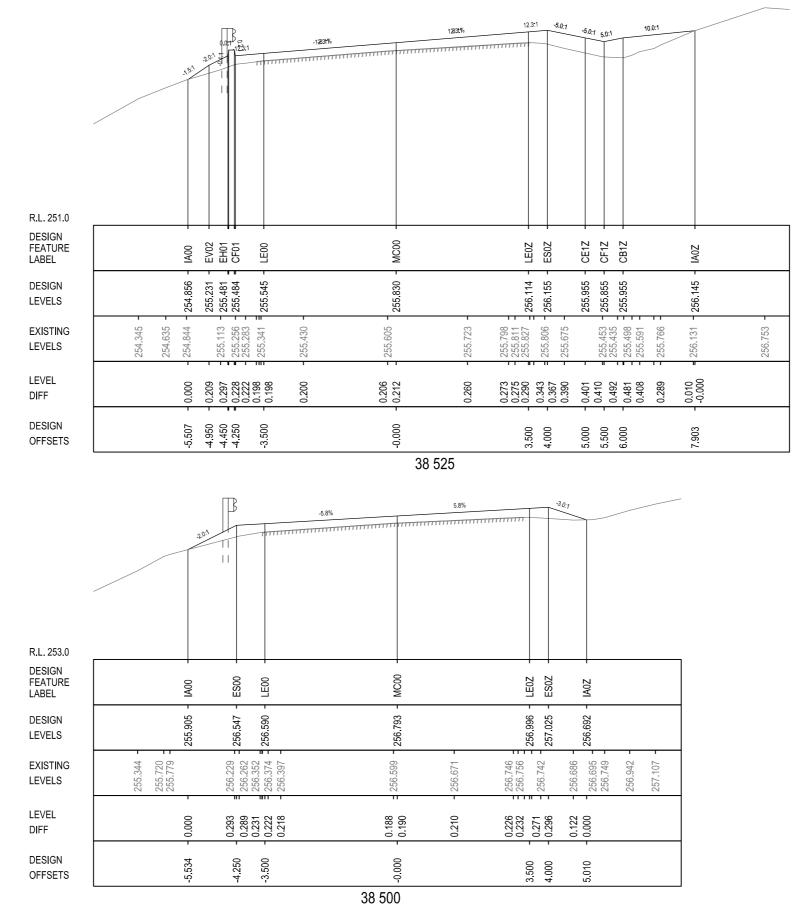


DESIGN MODEL FILE(S) USED FOR DOCUMENTATION OF THIS DRAWING HW16_MallanganeeRangeWillock_Design_IFC_V1.txt 11/07/2022 1:12:16 PM K:\PROJECTS\16_BRUXNER HIGHWAY\N2019070 Mallanganee Range and W∎ock st S5390_S5400\DRAWINGS\Final\DS2020-000063-04-RC.dgn N2019070 tightd REV DATE AMENDMENT / REVISION DESCRIPTION SCALES ON A3 SIZE DRAWING DRAWINGS / DESIGN PREPARED BY EXTERNAL REFERENCE FILES WVR No. APPROVAL TITLE D. TIGHT TRANSPORT FOR NSW DRAWN INFRASTRUCTURE & PLACE DRG CHECK D.JOHNSON for NSW ENGINEERING SERVICES DESIGN D. TIGHT ROAD DESIGN NORTHERN D.JOHNSON DESIGN CHECK REGIONAL MAINTENANCE
REGIONAL MAINTENANCE DELIVERY NORTHERN ISSUE STATUS
PROJECT MANAGEMENT NORTHERN DETAIL DES D.JOHNSON DESIGN MANAGER CO-ORDINATE SYSTEM HEIGHT DATUM MGA ZONE 56 R. GERSERKOWSKI


KYOGLE COUNCIL HW16 - BRUXNER HIGHWAY

Transport MALLANGANEE RANGE - WILLOCK STREET S5390-5400 37.52km TO 39.66km FROM CASINO

CROSS SECTIONS HW16 - BRUXNER HIGHWAY - MC00 - 38 325 TO 38 350


DS2020/000063 TfNSW REGISTRATION No. RC-0012 DETAIL DESIGN

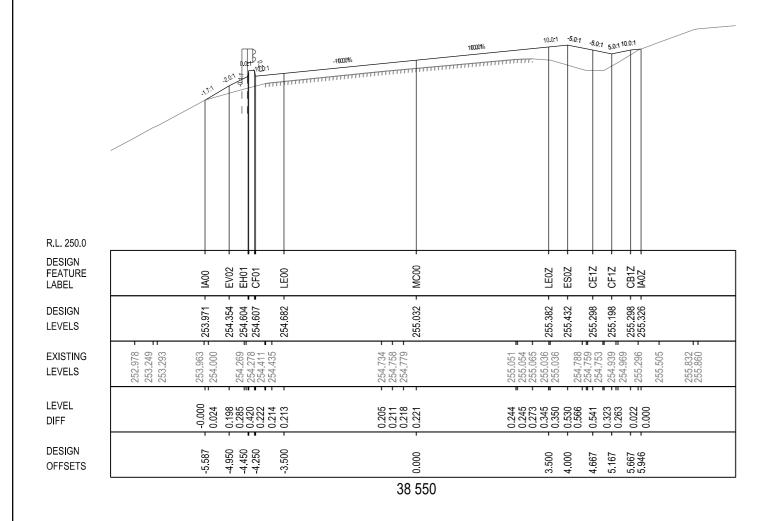


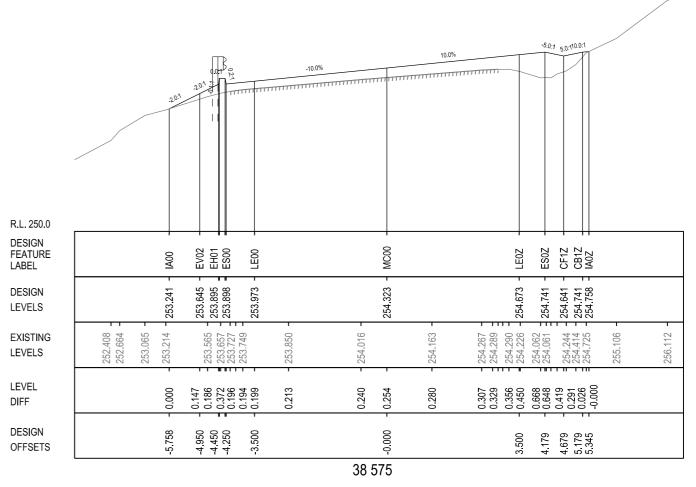

© Transport for NSW


KYOGLE COUNCIL HW16 - BRUXNER HIGHWAY DESIGN MODEL FILE(S) USED FOR DOCUMENTATION OF THIS DRAWING 11/07/2022 1:12:17 PM K:\PROJECTS\16_BRUXNER HIGHWAY\N2019070 Mallanganee Range and Walock st S5390_S5400\DRAWINGS\Final\DS2020-000063-04-RC.dgr N2019070 HW16_MallanganeeRangeWillock_Design_IFC_V1.txt tightd Transport MALLANGANEE RANGE - WILLOCK STREET S5390-5400 37.52km TO 39.66km FROM CASINO REV DATE AMENDMENT / REVISION DESCRIPTION SCALES ON A3 SIZE DRAWING DRAWINGS / DESIGN PREPARED BY EXTERNAL REFERENCE FILES WVR No. APPROVAL TITLE D. TIGHT TRANSPORT FOR NSW DRAWN 4 INFRASTRUCTURE & PLACE CROSS SECTIONS HW16 - BRUXNER HIGHWAY - MC00 - 38 375 TO 38 400 DRG CHECK D.JOHNSON for NSW ENGINEERING SERVICES DESIGN D. TIGHT ROAD DESIGN NORTHERN DS2020/000063 TfNSW REGISTRATION No. D.JOHNSON REGIONAL MAINTENANCE
REGIONAL MAINTENANCE DELIVERY NORTHERN ISSUE STATUS
PROJECT MANAGEMENT NORTHERN DETAIL DES D.JOHNSON DESIGN MANAGER CO-ORDINATE SYSTEM HEIGHT DATUM RC-0013 MGA ZONE 56 PROJECT MANAGER R. GERSERKOWSKI DETAIL DESIGN

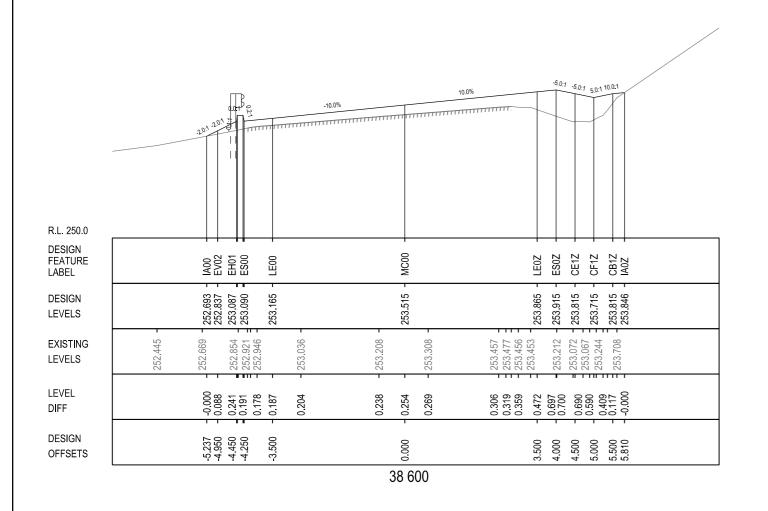


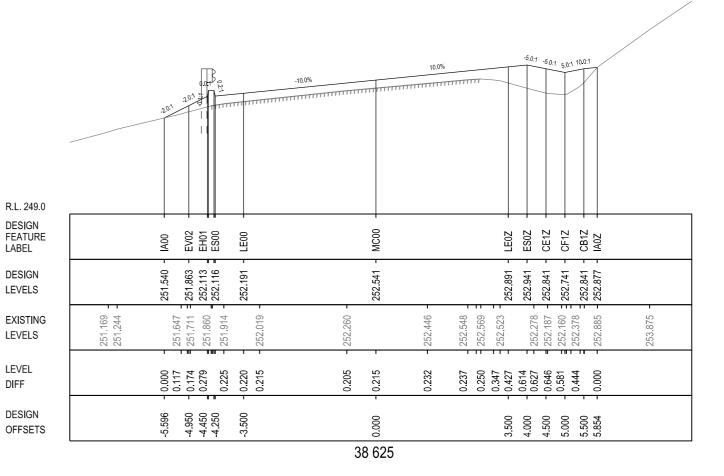


© Transport for NSW


DESIGN MODEL FILE(S) USED FOR DOCUMENTATION OF THIS DRAWING KYOGLE COUNCIL HW16 - BRUXNER HIGHWAY 11/07/2022 1:12:17 PM K:\PROJECTS\16_BRUXNER HIGHWAY\N2019070 Mallanganee Range and Walock st S5390_S5400\DRAWINGS\Final\DS2020-000063-04-RC.dgr N2019070 HW16_MallanganeeRangeWillock_Design_IFC_V1.txt tightd Transport MALLANGANEE RANGE - WILLOCK STREET S5390-5400 37.52km TO 39.66km FROM CASINO REV DATE AMENDMENT / REVISION DESCRIPTION SCALES ON A3 SIZE DRAWING DRAWINGS / DESIGN PREPARED BY EXTERNAL REFERENCE FILES WVR No. APPROVAL TITLE D. TIGHT TRANSPORT FOR NSW DRAWN CROSS SECTIONS HW16 - BRUXNER HIGHWAY - MC00 - 38 425 TO 38 500 4 INFRASTRUCTURE & PLACE DRG CHECK D.JOHNSON for NSW ENGINEERING SERVICES DESIGN D. TIGHT ROAD DESIGN NORTHERN DS2020/000063 TfNSW REGISTRATION No. D.JOHNSON REGIONAL MAINTENANCE
REGIONAL MAINTENANCE DELIVERY NORTHERN ISSUE STATUS
PROJECT MANAGEMENT NORTHERN DETAIL DES D.JOHNSON DESIGN MANAGER CO-ORDINATE SYSTEM HEIGHT DATUM RC-0014 MGA ZONE 56 PROJECT MANAGER R. GERSERKOWSKI DETAIL DESIGN

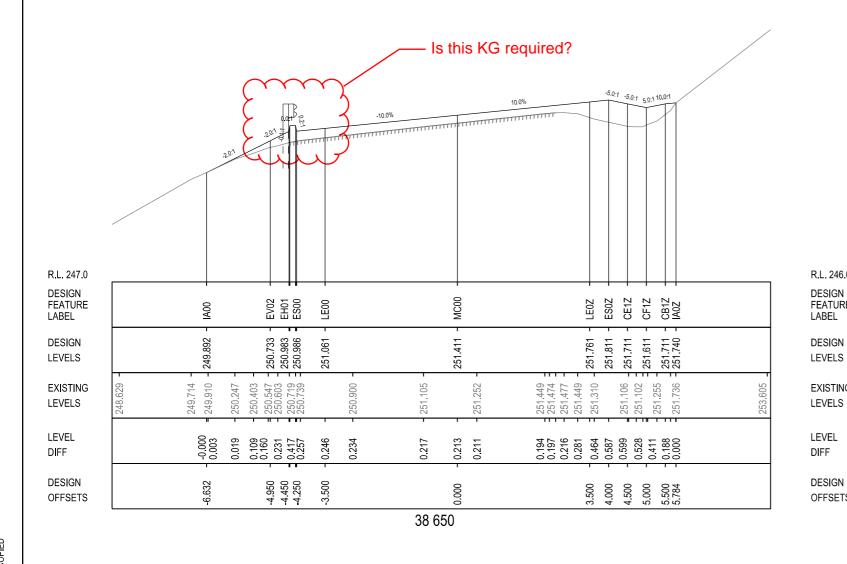

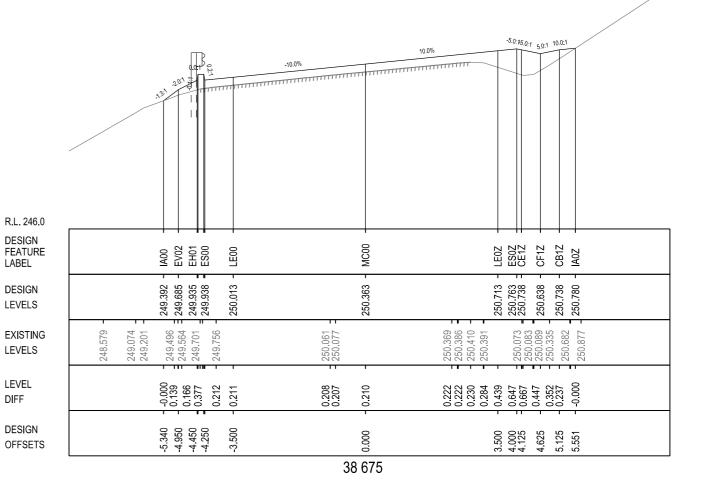

DESIGN MODEL FILE(S) USED FOR DOCUMENTATION OF THIS DRAWING KYOGLE COUNCIL HW16 - BRUXNER HIGHWAY 11/07/2022 1:12:17 PM K:\PROJECTS\16_BRUXNER HIGHWAY\N2019070 Mallanganee Range and Walock st S5390_S5400\DRAWINGS\Final\DS2020-000063-04-RC.dgr N2019070 HW16_MallanganeeRangeWillock_Design_IFC_V1.txt tightd Transport MALLANGANEE RANGE - WILLOCK STREET S5390-5400 37.52km TO 39.66km FROM CASINO REV DATE AMENDMENT / REVISION DESCRIPTION SCALES ON A3 SIZE DRAWING DRAWINGS / DESIGN PREPARED BY EXTERNAL REFERENCE FILES WVR No. APPROVAL TITLE D. TIGHT TRANSPORT FOR NSW DRAWN CROSS SECTIONS HW16 - BRUXNER HIGHWAY - MC00 - 38 525 4 INFRASTRUCTURE & PLACE DRG CHECK D.JOHNSON for NSW ENGINEERING SERVICES ROAD DESIGN NORTHERN DESIGN D. TIGHT DS2020/000063 TfNSW REGISTRATION No. DESIGN CHECK D.JOHNSON REGIONAL MAINTENANCE
REGIONAL MAINTENANCE DELIVERY NORTHERN ISSUE STATUS
PROJECT MANAGEMENT NORTHERN DETAIL DES D.JOHNSON DESIGN MANAGER CO-ORDINATE SYSTEM HEIGHT DATUM RC-0015 MGA ZONE 56 PROJECT MANAGER R. GERSERKOWSKI DETAIL DESIGN

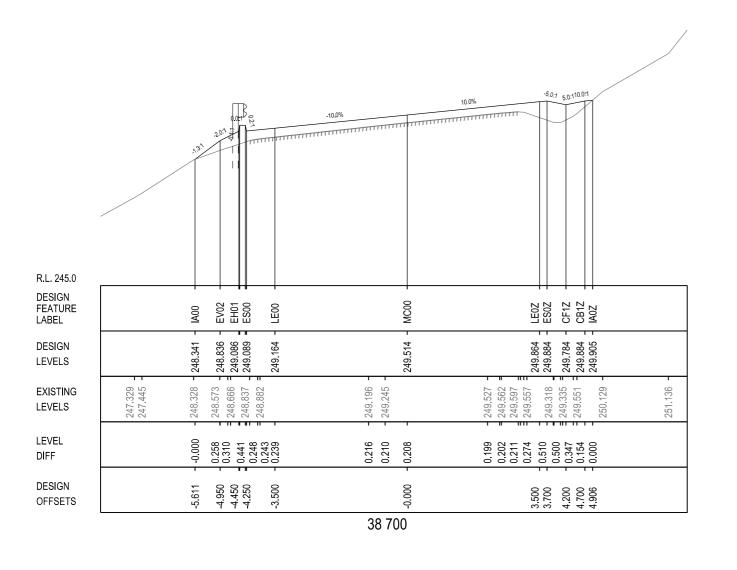

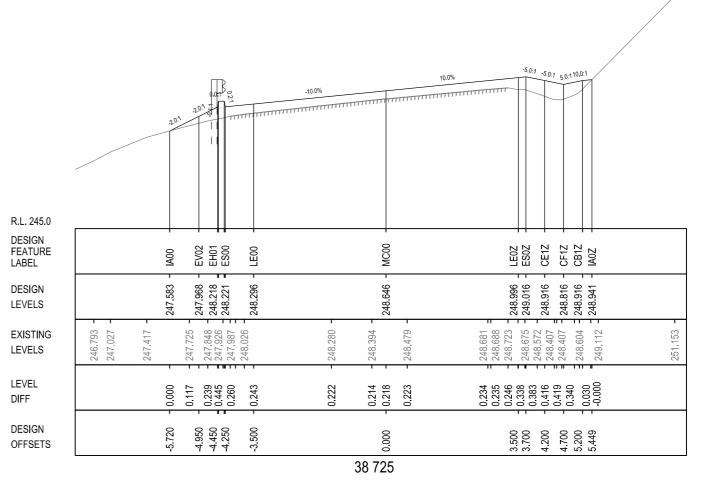


© Transport for NSW


Transport


KYOGLE COUNCIL
HW16 - BRUXNER HIGHWAY
MALLANGANEE RANGE - WILLOCK STREET S5390-5400
37.52km TO 39.66km FROM CASINO DESIGN MODEL FILE(S) USED FOR DOCUMENTATION OF THIS DRAWING 11/07/2022 1:12:18 PM K:\PROJECTS\16_BRUXNER HIGHWAY\N2019070 Mallanganee Range and Walock st S5390_S5400\DRAWINGS\Final\DS2020-000063-04-RC.dgr N2019070 HW16_MallanganeeRangeWillock_Design_IFC_V1.txt tightd REV DATE AMENDMENT / REVISION DESCRIPTION SCALES ON A3 SIZE DRAWING DRAWINGS / DESIGN PREPARED BY EXTERNAL REFERENCE FILES WVR No. APPROVAL TITLE D. TIGHT TRANSPORT FOR NSW DRAWN CROSS SECTIONS HW16 - BRUXNER HIGHWAY - MC00 - 38 550 TO 38 575 4 INFRASTRUCTURE & PLACE DRG CHECK D.JOHNSON for NSW ENGINEERING SERVICES DESIGN D. TIGHT ROAD DESIGN NORTHERN DS2020/000063 TfNSW REGISTRATION No. D.JOHNSON REGIONAL MAINTENANCE
REGIONAL MAINTENANCE DELIVERY NORTHERN ISSUE STATUS
PROJECT MANAGEMENT NORTHERN DETAIL DES D.JOHNSON DESIGN MANAGER CO-ORDINATE SYSTEM HEIGHT DATUM RC-0016 MGA ZONE 56 PROJECT MANAGER R. GERSERKOWSKI DETAIL DESIGN

10 | 15 | 20 | 25 | 30 | 35 | 40 | 45 | 50mm ON A3 SIZE ORIGINAL

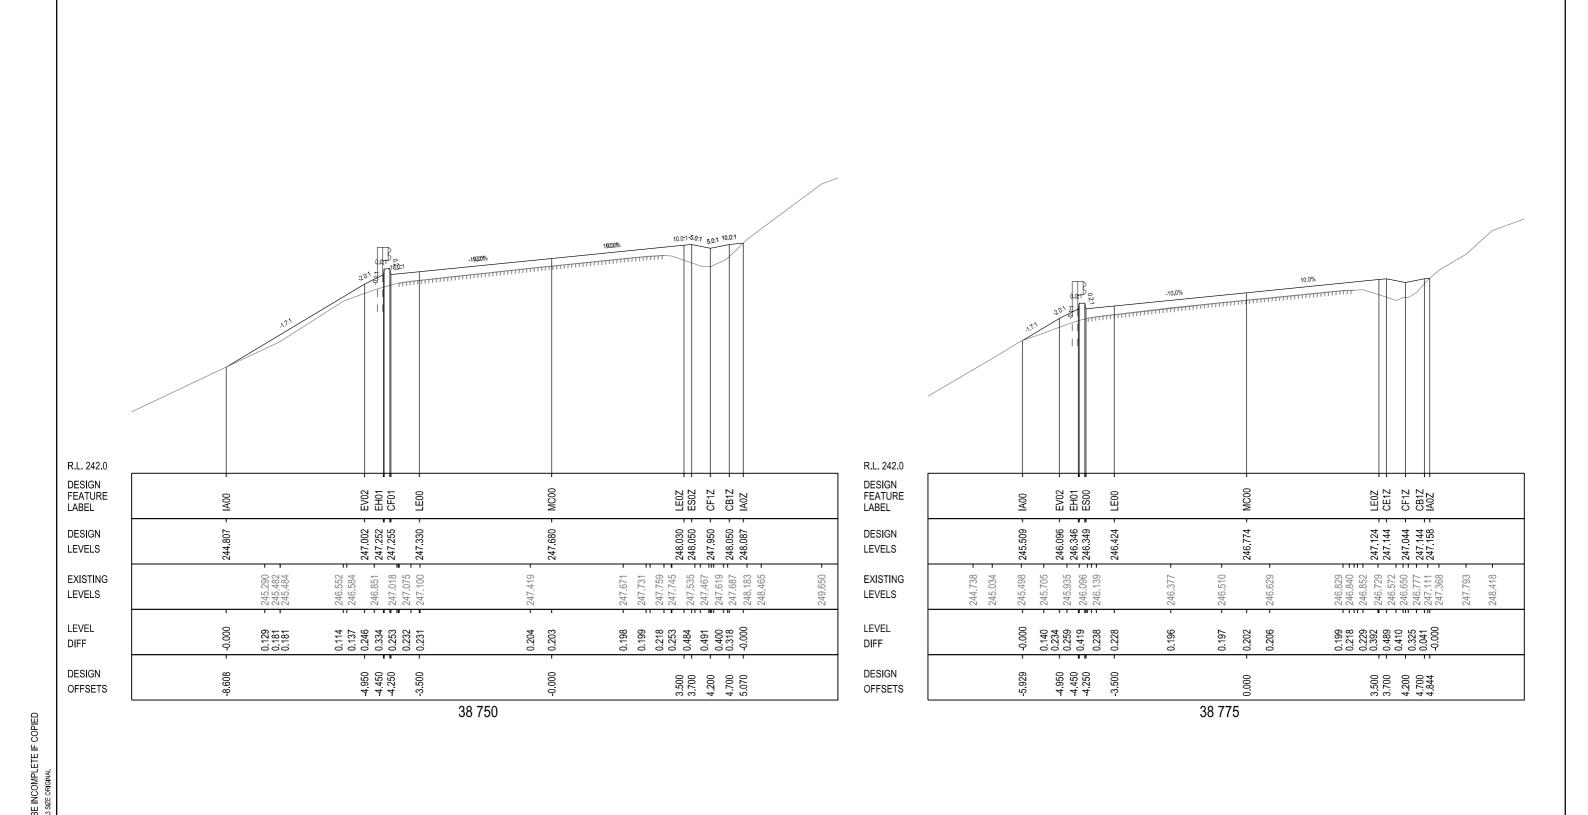


AR 30															
品	DRAWING FILE LOCATION / NAME				DESIGN L		DESIGN MODEL FILE(S) USED FOR DOCUMENTATION OF TI		PLOT DATE / TIME	PLOT BY	CLIENT		KYOGLE COUNCIL		\(\Delta \)
R 25	K:\PROJECTS\16_BRUXNER HIGHWAY\N2019070	70 Mallanganee Range and Willock s	t S5390_S54	400\DRAWINGS\Final\DS2020-000063-04-RC.dgn	N20190	70	HW16_MallanganeeRangeWillock_Design_IFC	C_V1.txt	11/07/2022 1:12:18	PM tightd		I .	HW16 - BRUXNER HIGH		[70]
H 0	EXTERNAL REFERENCE FILES	REV DAT	ΓE A	MENDMENT / REVISION DESCRIPTION	WVR No.	APPROVAL	SCALES ON A3 SIZE DRAWING	DRAWINGS / DESIGN PREPARED BY	TITLE	NAME	MYK		MALLANGANEE F	RANGE - WILLOCK STR	REET S5390-5400
` ≽								TRANSPORT FOR NSW	DRAWN	D. TIGHT		Transport	37.52km TO 39.66	km FROM CASINO	
3 M							0 1 2 3 4	INFRASTRUCTURE & PLACE	DRG CHECK	D.JOHNSON	NSW		CROSS SECTION	S	
¥ º							SCALE 1:100m	ENGINEERING SERVICES	DESIGN	D. TIGHT	GOVERNMENT	for NSW		WAY - MC00 - 38 600 TO 38 625	5
& —								ROAD DESIGN NORTHERN	DESIGN CHECK	D.JOHNSON	PREPARED FOR		TfNSW REGISTRATION No.	DS2020/000063	PART
50							CO-ORDINATE SYSTEM HEIGHT DATUM	-	DESIGN MANAGER	D.JOHNSON	REGIONAL MAINT	ENANCE ENANCE DELIVERY NORTHERN		EDMS No.	SHEET No. ISSUE
Ë ∘							MGA ZONE 56 AHD		PROJECT MANAGER	R. GERSERKOWSKI			DETAIL DESIGN	QA4331765	RC-0017 ISSUE
									_						© Transport for NSW

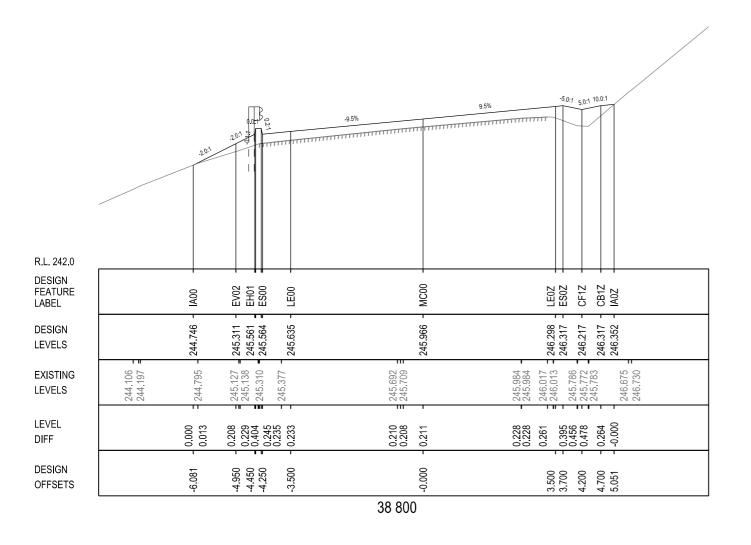


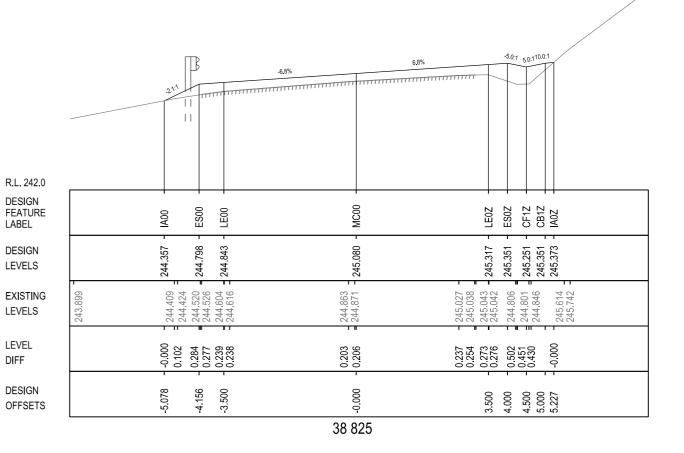

© Transport for NSW

KYOGLE COUNCIL HW16 - BRUXNER HIGHWAY DESIGN MODEL FILE(S) USED FOR DOCUMENTATION OF THIS DRAWING 11/07/2022 1:12:18 PM K:\PROJECTS\16_BRUXNER HIGHWAY\N2019070 Mallanganee Range and Walock st S5390_S5400\DRAWINGS\Final\DS2020-000063-04-RC.dgr N2019070 HW16_MallanganeeRangeWillock_Design_IFC_V1.txt tightd Transport MALLANGANEE RANGE - WILLOCK STREET S5390-5400 37.52km TO 39.66km FROM CASINO REV DATE AMENDMENT / REVISION DESCRIPTION SCALES ON A3 SIZE DRAWING DRAWINGS / DESIGN PREPARED BY EXTERNAL REFERENCE FILES WVR No. APPROVAL TITLE D. TIGHT TRANSPORT FOR NSW DRAWN CROSS SECTIONS HW16 - BRUXNER HIGHWAY - MC00 - 38 650 TO 38 675 INFRASTRUCTURE & PLACE DRG CHECK D.JOHNSON for NSW ENGINEERING SERVICES DESIGN D. TIGHT ROAD DESIGN NORTHERN DS2020/000063 D.JOHNSON TfNSW REGISTRATION No. DESIGN CHECK REGIONAL MAINTENANCE
REGIONAL MAINTENANCE DELIVERY NORTHERN ISSUE STATUS
PROJECT MANAGEMENT NORTHERN DETAIL DES D.JOHNSON DESIGN MANAGER HEIGHT DATUM RC-0018 MGA ZONE 56 PROJECT MANAGER R. GERSERKOWSKI DETAIL DESIGN

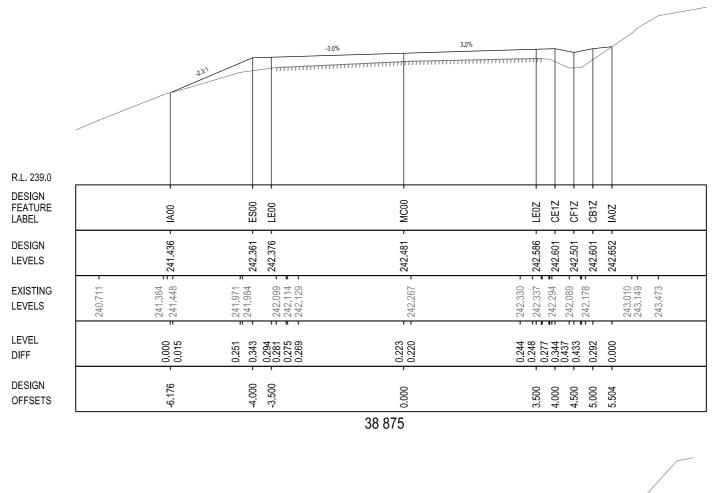

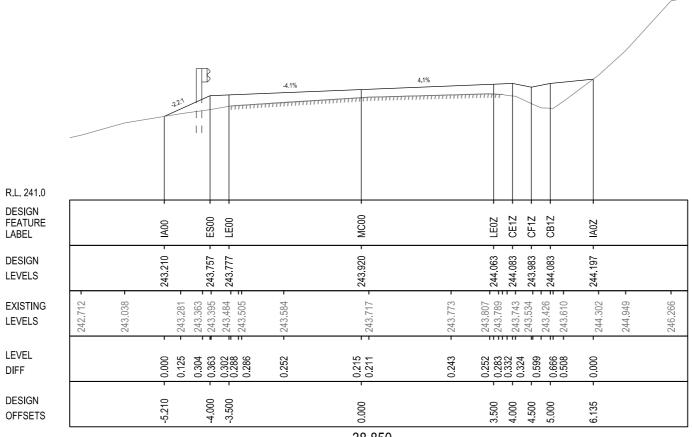

38 850

2													
	DRAWING FILE LOCATION / NAME K:\PROJECTS\16_BRUXNER HIGHWAY\N2019070 Mallanganee Range a	and Wil	lock st S5390_	S5400\DRAWINGS\Final\DS2020-000063-04-RC.dgn	DESIGN LO N201907		DESIGN MODEL FILE(S) USED FOR DOCUMENTATION OF THIS HW16_MallanganeeRangeWillock_Design_IFC_		PLOT DATE / TIME 11/07/2022 1:12:19	PLOT BY tightd	CLIENT		KYOGLE (HW16 - BI
	EXTERNAL REFERENCE FILES	REV	DATE	AMENDMENT / REVISION DESCRIPTION	WVR No.	APPROVAL	SCALES ON A3 SIZE DRAWING	DRAWINGS / DESIGN PREPARED BY	TITLE	NAME			MALLA
_								TRANSPORT FOR NSW	DRAWN	D. TIGHT		Transport	37.52kr
:								INFRASTRUCTURE & PLACE	DRG CHECK	D.JOHNSON			cross
								ENGINEERING SERVICES	DESIGN	D. TIGHT	GOVERNMENT	for NSW	HW16 - BI
								ROAD DESIGN NORTHERN	DESIGN CHECK	D.JOHNSON	PREPARED FOR		TfNSW REGIS
-							CO-ORDINATE SYSTEM HEIGHT DATUM		DESIGN MANAGER	D.JOHNSON	REGIONAL MAINTE	:NANCE ENANCE DELIVERY NORTHERN	ISSUE STATE
,							MGA ZONE 56 AHD		PROJECT MANAGER	R. GERSERKOWSKI	PROJECT MANAGE		DETAIL D

NOT FOR CONSTRUCTION


GLE COUNCIL S - BRUXNER HIGHWAY LANGANEE RANGE - WILLOCK STREET S5390-5400 2km TO 39.66km FROM CASINO

DSS SECTIONS

1W 10 - BRUXNER HIGH	100A1 - 101CUU -	38 700			
TINSW REGISTRATION No.	DS2020)/000063		PART 1	1
SSUE STATUS DETAIL DESIGN		EDMS No. QA4331765	SHEET No. RC-0019	A	1

RC-0019 A

-3.0%

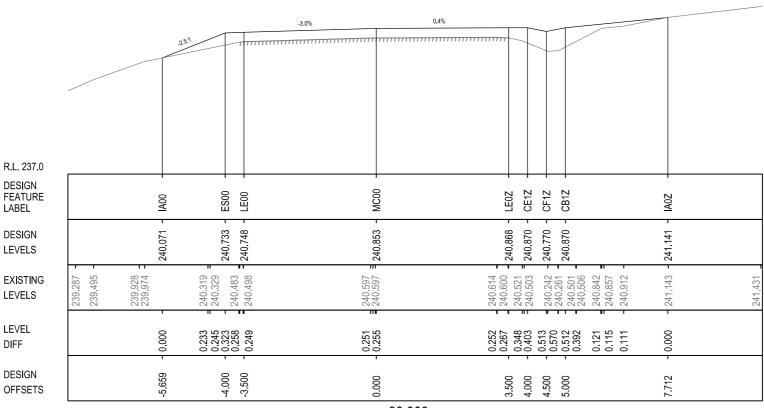

38 900

NOT FOR CONSTRUCTION


DESIGN MODEL FILE(S) USED FOR DOCUMENTATION OF THIS DRAWING 11/07/2022 1:12:19 PM K:\PROJECTS\16_BRUXNER HIGHWAY\N2019070 Mallanganee Range and Walock st S5390_S5400\DRAWINGS\Final\DS2020-000063-04-RC.dgr N2019070 HW16_MallanganeeRangeWillock_Design_IFC_V1.txt tightd REV DATE AMENDMENT / REVISION DESCRIPTION SCALES ON A3 SIZE DRAWING DRAWINGS / DESIGN PREPARED BY EXTERNAL REFERENCE FILES WVR No. APPROVAL TITLE D. TIGHT TRANSPORT FOR NSW DRAWN INFRASTRUCTURE & PLACE DRG CHECK D.JOHNSON for NSW ENGINEERING SERVICES D. TIGHT DESIGN ROAD DESIGN NORTHERN DESIGN CHECK D.JOHNSON REGIONAL MAINTENANCE
REGIONAL MAINTENANCE DELIVERY NORTHERN ISSUE STATUS
PROJECT MANAGEMENT NORTHERN DETAIL DES D.JOHNSON DESIGN MANAGER CO-ORDINATE SYSTEM HEIGHT DATUM MGA ZONE 56 PROJECT MANAGER R. GERSERKOWSKI DETAIL DESIGN

KYOGLE COUNCIL HW16 - BRUXNER HIGHWAY Transport MALLANGANEE RANGE - WILLOCK STREET S5390-5400 37.52km TO 39.66km FROM CASINO

CROSS SECTIONS
HW16 - BRUXNER HIGHWAY - MC00 - 38 725

DS2020/000063 TfNSW REGISTRATION No.

RC-0020 © Transport for NSW

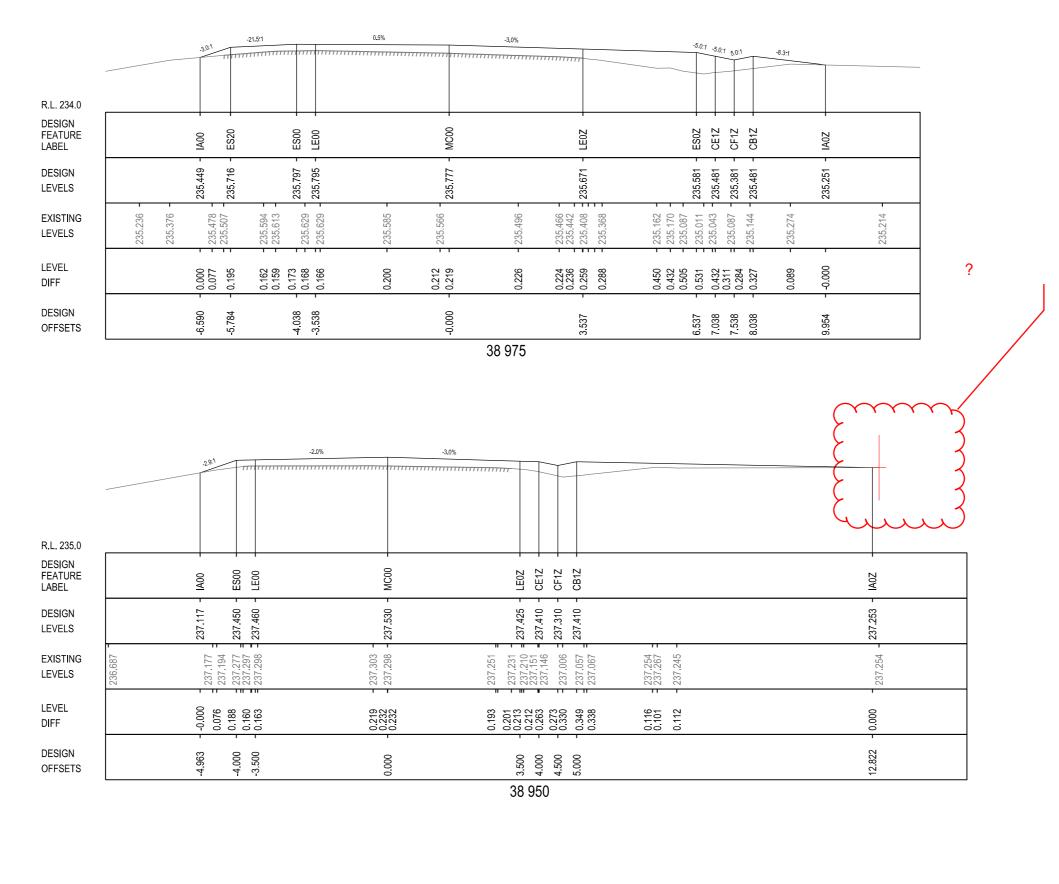


DESIGN MODEL FILE(S) USED FOR DOCUMENTATION OF THIS DRAWING 11/07/2022 1:12:19 PM K:\PROJECTS\16_BRUXNER HIGHWAY\N2019070 Mallanganee Range and Walock st S5390_S5400\DRAWINGS\Final\DS2020-000063-04-RC.dgr N2019070 HW16_MallanganeeRangeWillock_Design_IFC_V1.txt tightd REV DATE AMENDMENT / REVISION DESCRIPTION SCALES ON A3 SIZE DRAWING DRAWINGS / DESIGN PREPARED BY EXTERNAL REFERENCE FILES WVR No. APPROVAL TITLE D. TIGHT TRANSPORT FOR NSW DRAWN INFRASTRUCTURE & PLACE DRG CHECK D.JOHNSON for NSW ENGINEERING SERVICES DESIGN D. TIGHT ROAD DESIGN NORTHERN D.JOHNSON TfNSW REGISTRATION No. DESIGN CHECK REGIONAL MAINTENANCE
REGIONAL MAINTENANCE DELIVERY NORTHERN ISSUE STATUS
PROJECT MANAGEMENT NORTHERN DETAIL DES D.JOHNSON DESIGN MANAGER CO-ORDINATE SYSTEM HEIGHT DATUM MGA ZONE 56 PROJECT MANAGER R. GERSERKOWSKI DETAIL DESIGN

KYOGLE COUNCIL HW16 - BRUXNER HIGHWAY

Transport MALLANGANEE RANGE - WILLOCK STREET S5390-5400 37.52km TO 39.66km FROM CASINO

CROSS SECTIONS HW16 - BRUXNER HIGHWAY - MC00 - 38 750 TO 38 775

DS2020/000063 PA SHEET NO. QA4331765 RC-0021 RC

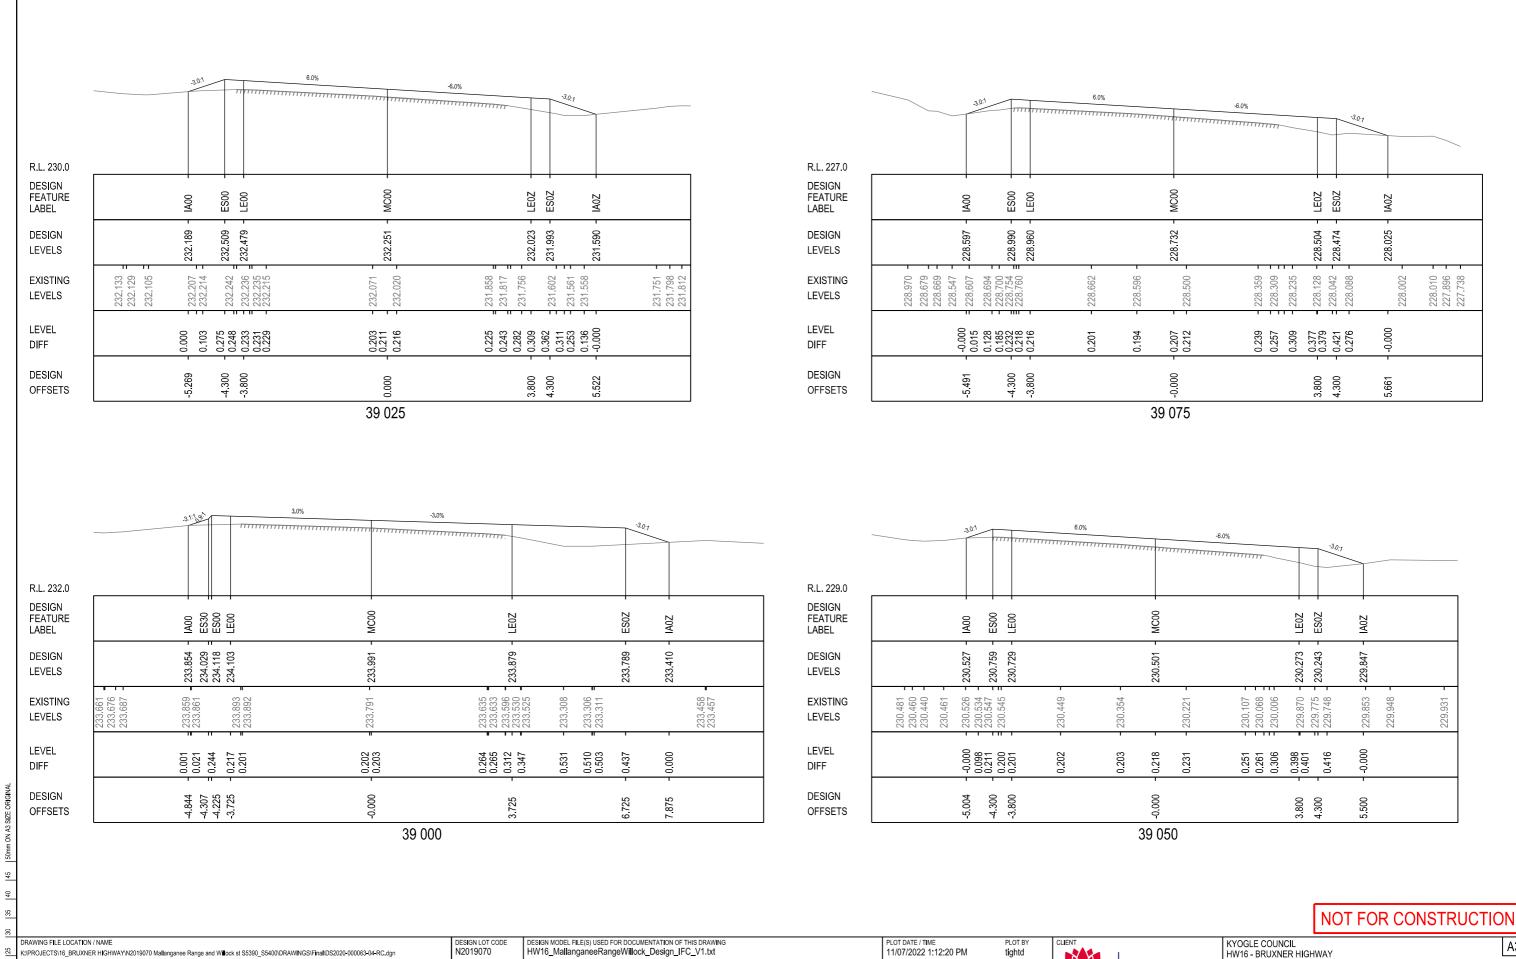

DRAWINGS / DESIGN PREPARED BY

TRANSPORT FOR NSW

INFRASTRUCTURE & PLACE

ENGINEERING SERVICES

ROAD DESIGN NORTHERN

11/07/2022 1:12:20 PM

TITLE

DRAWN

DESIGN

DRG CHECK

DESIGN MANAGER

NAME

D. TIGHT

D. TIGHT

D.JOHNSON

D.JOHNSON

D.JOHNSON

R. GERSERKOWSKI

tightd

EXTERNAL REFERENCE FILES

CIPROJECTS\16_BRUXNER HIGHWAY\N2019070 Mailanganee Range and W≣ock st \$5390_S5400\DRAWINGS\Final\DS2020-000063-04-RC.dgr

REV DATE AMENDMENT / REVISION DESCRIPTION

N2019070

WVR No. APPROVAL

HW16_MallanganeeRangeWillock_Design_IFC_V1.txt

HEIGHT DATUM

SCALES ON A3 SIZE DRAWING

CO-ORDINATE SYSTEM

MGA ZONE 56

DS2020/000063 RC-0022

Transport MALLANGANEE RANGE - WILLOCK STREET S5390-5400 37.52km TO 39.66km FROM CASINO

TfNSW REGISTRATION No.

for NSW

REGIONAL MAINTENANCE DELIVERY NORTHERN ISSUE STATUS

REGIONAL MAINTENANCE

PROJECT MANAGEMENT NORTHERN

CROSS SECTIONS HW16 - BRUXNER HIGHWAY - MC00 - 38 800 TO 38 825



INFRASTRUCTURE & PLACE

ENGINEERING SERVICES

ROAD DESIGN NORTHERN

CO-ORDINATE SYSTEM

MGA ZONE 56

HEIGHT DATUM

DRG CHECK

DESIGN MANAGER

DESIGN

D.JOHNSON

D.JOHNSON

D.JOHNSON

R. GERSERKOWSKI

D. TIGHT

CROSS SECTIONS
HW16 - BRUXNER HIGHWAY - MC00 - 38 850 TO 38 875

TfNSW REGISTRATION No.

DETAIL DESIGN

DS2020/000063

RC-0023


© Transport for NSW


for NSW


REGIONAL MAINTENANCE
REGIONAL MAINTENANCE DELIVERY NORTHERN ISSUE STATUS


PROJECT MANAGEMENT NORTHERN

THIS DRAWING MAY BE PREPARED IN COLOUR AND MAY BE INCOMPLETI

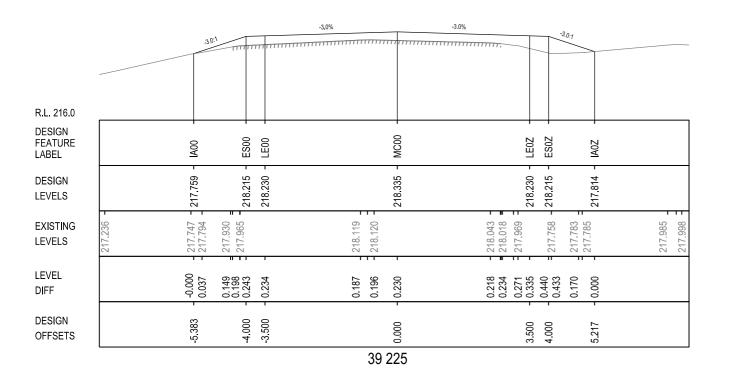

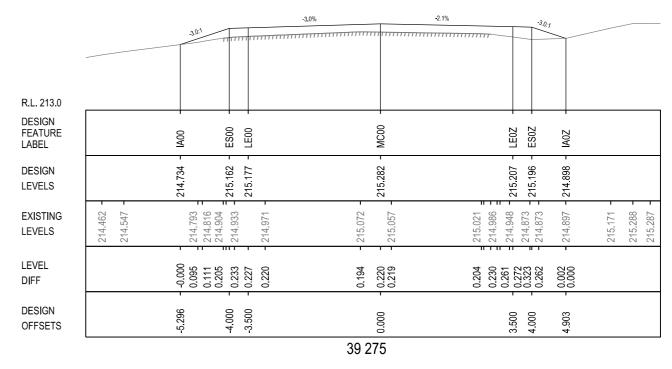


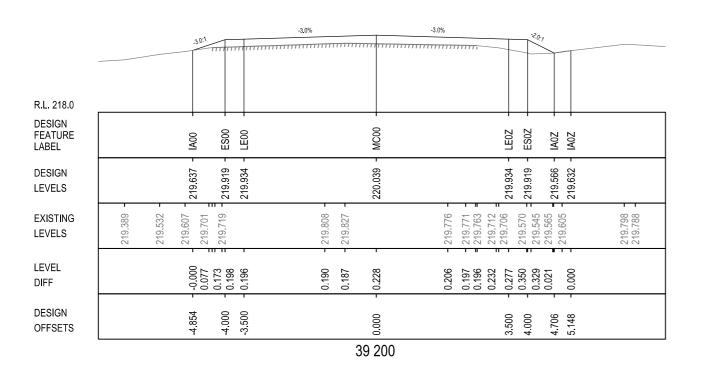

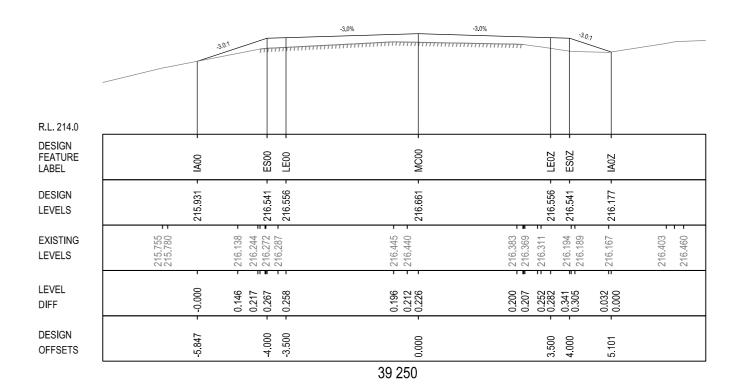



NOT FOR CONCERNATION


ARED 1											NOT	FOR CONS	STRUCTIC)N
PREP/	DRAWING FILE LOCATION / NAME K:PROJECTS\16_BRUXNER HIGHWAY\N2019070 Mailanganee Range :	and W a ock st S5	390_S5400\DRAWINGS\Final\DS2020-000063-04-RC.dgn	DESIGN L N20190		DESIGN MODEL FILE(S) USED FOR DOCUMENTATION OF THE HW16_MallanganeeRangeWillock_Design_IFC		PLOT DATE / TIME 11/07/2022 1:12:21	PLOT BY PM tightd	CLIENT	KYOGLE COUNCIL HW16 - BRUXNER HIGHWAY			A3
B 00	EXTERNAL REFERENCE FILES	REV DATE	AMENDMENT / REVISION DESCRIPTION	WVR No.	APPROVAL	SCALES ON A3 SIZE DRAWING	DRAWINGS / DESIGN PREPARED BY	TITLE	NAME		MALLANGANEE RANGE -		EET S5390-54	400
` ₹							TRANSPORT FOR NSW	DRAWN	D. TIGHT	Transport	37.52km TO 39.66km FRO	M CASINO		
Z 5						0 1 2 3 4	INFRASTRUCTURE & PLACE	DRG CHECK	D.JOHNSON		CROSS SECTIONS			
₹ ∘						SCALE 1:100m	ENGINEERING SERVICES	DESIGN	D. TIGHT	GOVERNMENT for NSW	HW16 - BRUXNER HIGHWAY - MC0	00 - 38 900 TO 38 925		
- §							ROAD DESIGN NORTHERN	DESIGN CHECK	D.JOHNSON	PREPARED FOR	TfNSW REGISTRATION No. DS203	20/000063		PART
5.0						CO-ORDINATE SYSTEM HEIGHT DATUM	-	DESIGN MANAGER	D.JOHNSON	REGIONAL MAINTENANCE REGIONAL MAINTENANCE DELIVERY NORTHER		EDMS No.	I QUEET No.	ISSUE
Ħ °						MGA ZONE 56 AHD		PROJECT MANAGER	R. GERSERKOWSKI	PROJECT MANAGEMENT NORTHERN	DETAIL DESIGN	QA4331765	RC-0024	Ä
								-				•	© Transport for	NSW

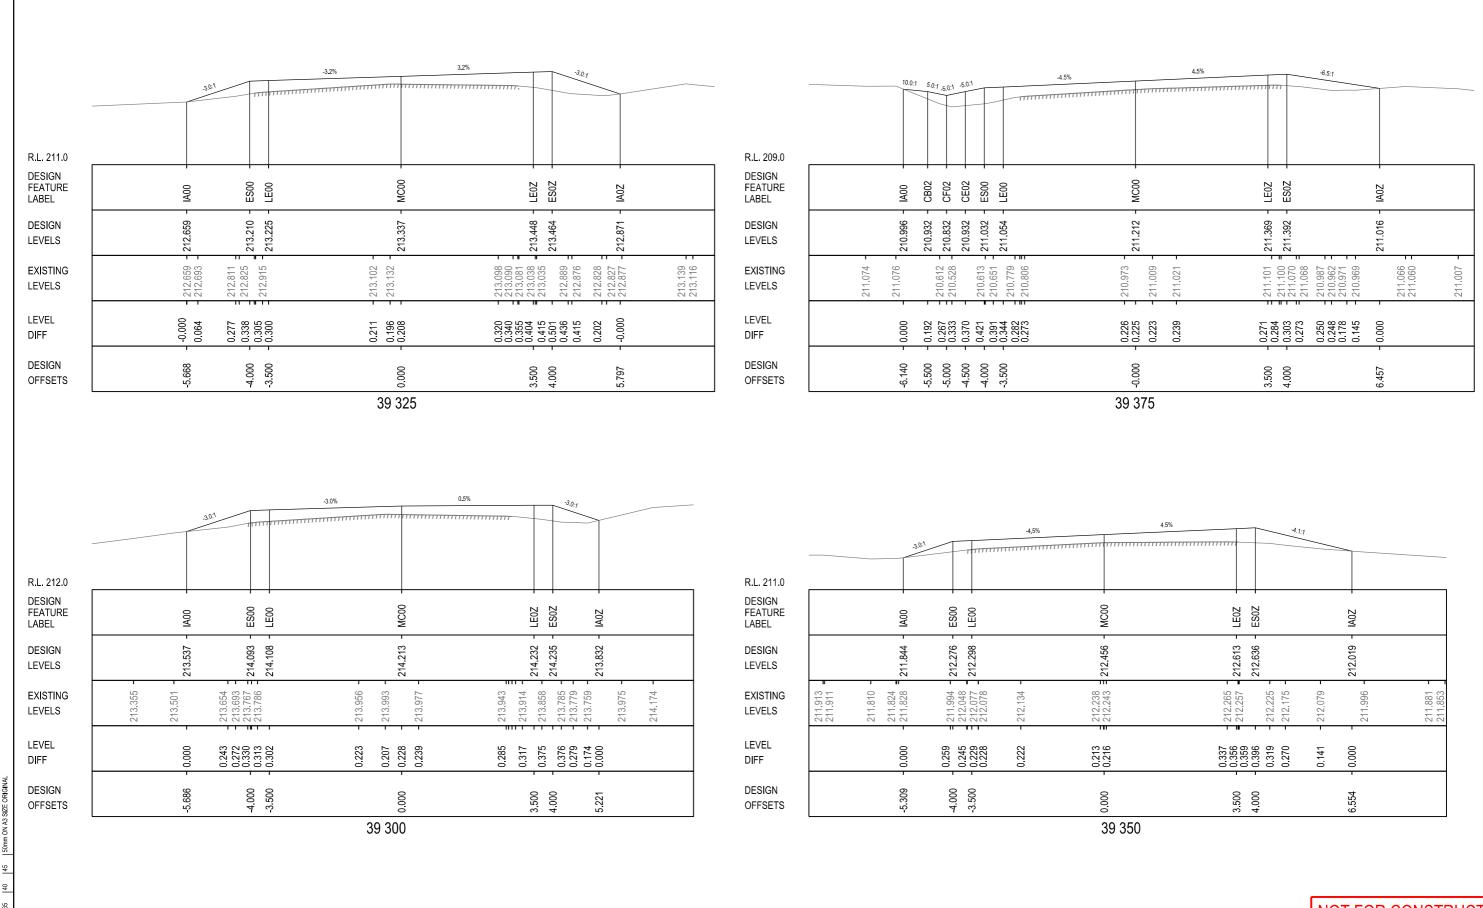


ARED	3														NOT FOR CONS	STRUCTION)N
PREP/	DRAWING FILE LOCATION / NAME K:\PROJECTS\16_BRUXNER HIGHWAY\N2019070 Mailanganee Range	and W a oc⊦	k st S5390_	_S5400\DRAWINGS\FinalDS2020-000063-04-RC.dgn	DESIGN LO N201907		DESIGN MODEL FILE(S) USED FOR DOCUMENTATION OF TH HW16_MallanganeeRangeWillock_Design_IFC		PLOT DATE / TIME 11/07/2022 1:12:21		OT BY	CLIENT	I	KYOGLE COUNCIL HW16 - BRUXNER HIGH			A3
H 0	EXTERNAL REFERENCE FILES	REV D	ATE	AMENDMENT / REVISION DESCRIPTION	WVR No.	APPROVAL	SCALES ON A3 SIZE DRAWING	DRAWINGS / DESIGN PREPARED BY	TITLE	NAME		XIYIK		MALLANGANEE F	RANGE - WILLOCK STR	EET S5390-5	400
≽ <u>=</u>	`							TRANSPORT FOR NSW	DRAWN	D. TIGHT			Transport	37.52km TO 39.66	km FROM CASINO		
. ₹	2						0 1 2 3 4	INFRASTRUCTURE & PLACE	DRG CHECK	D.JOHNSON		NSW		CROSS SECTION	S		
ĕ ∘							SCALE 1:100m	ENGINEERING SERVICES	DESIGN	D. TIGHT		GOVERNMENT	for NSW		WAY - MC00 - 38 950 TO 38 975		
- &	7							ROAD DESIGN NORTHERN	DESIGN CHECK	D.JOHNSON		PREPARED FOR		TfNSW REGISTRATION No.	DS2020/000063		PART
5 5 5 5							CO-ORDINATE SYSTEM HEIGHT DATUM	-	DESIGN MANAGER	D.JOHNSON		REGIONAL MAINTE	ENANCE ENANCE DELIVERY NORTHERN			SHEET No.	ISSUE
Ĕ.	,						MGA ZONE 56 AHD		PROJECT MANAGER	R. GERSERKO				DETAIL DESIGN	QA4331765	RC-0025	Ä
. –				'			•	•							•	@ Transport fo	r NSW

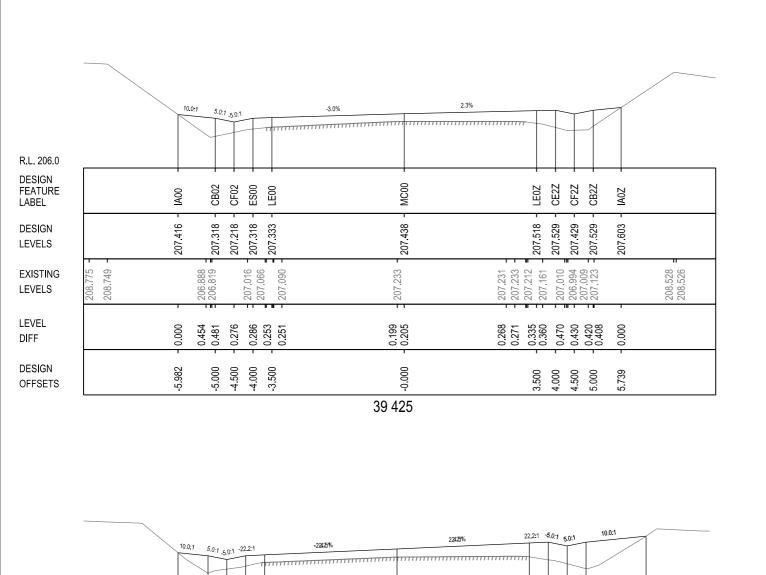


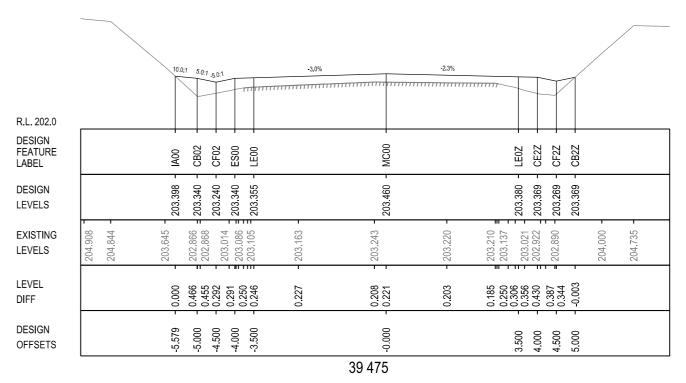


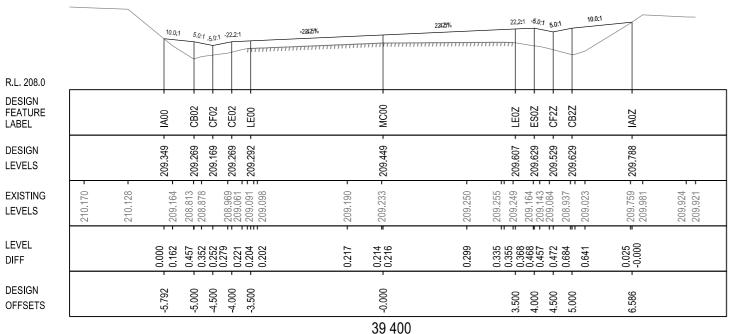


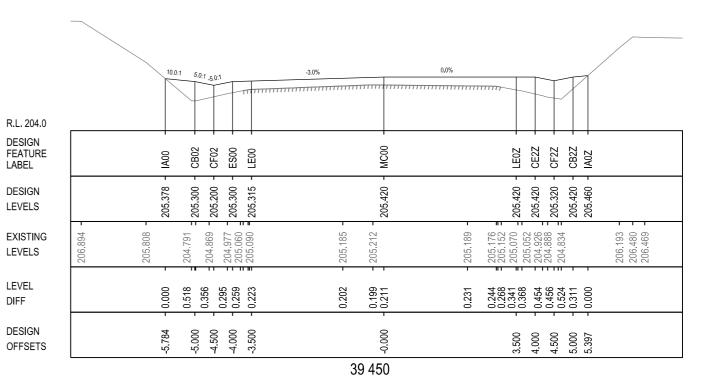


		* * * * * *		39 400		€ 4 4 E	9		<u> </u>	r	39 450	w 4 4 m	t)
DESIGN OFFSETS		-5.792 - -5.000 - -4.500 - -4.000 -		- 000.0		3.500 - 4.000 - 4.500 - 5.000 -	.586 -	DESIGN OFFSETS	-5.784 - -5.000 - -4.500 - -4.000 -		- 0000	3.500 - 4.000 - 4.500 - 5.000 -	397
LEVEL DIFF		0.000 0.162 0.457 0.352 0.252 0.279 0.204	0.202	0.217 0.214 0.216	0.299	0.335 0.355 0.368 0.468 0.457 0.684	0.025	LEVEL DIFF	0.000 0.518 0.356 0.295 0.259	277.0	0.202	0.231 0.244 0.268 0.341 0.368 0.454 0.456	0.000
LEVEL	21 21	0.000 0.162 - 20 0.252 - 20 0.252 - 20 0.279 - 20 0.224 - 20 0.204 - 20		0.217 - 2	0.299	0.335 0.355 0.368 0.468 0.457 0.684	0.025		0.000 0.518 0.356 0.295 0.259	0.22.0	0.202 - 0.199 - 0.211 -	0.231 0.244 0.268 0.341 0.368	

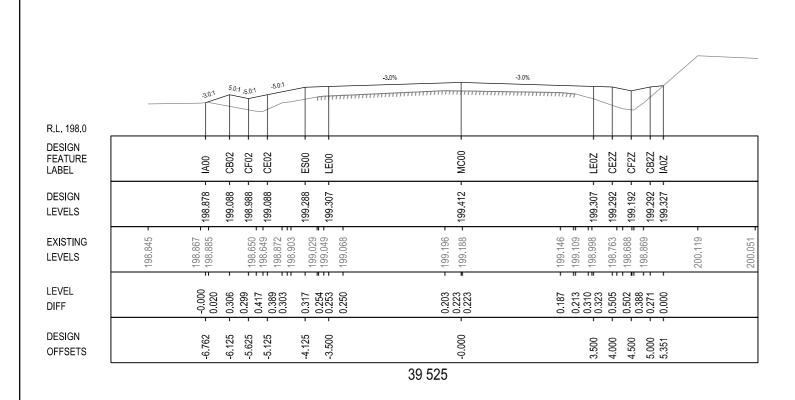


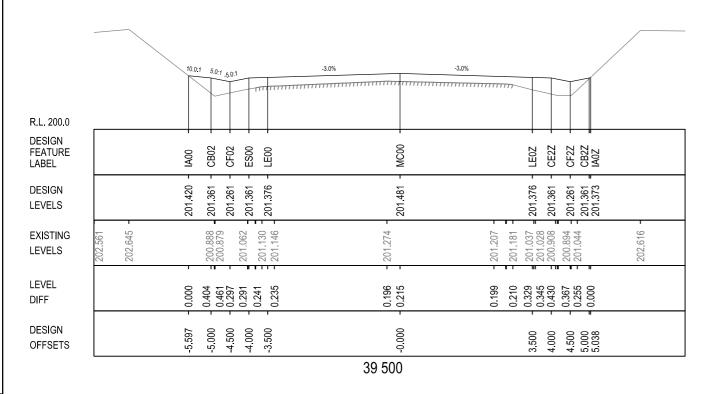

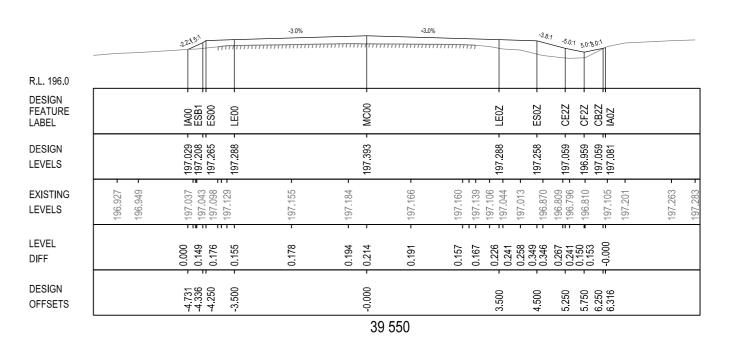


			39 500							39 550					
													NOT FO	R CONS	TRUC
WING FILE LOCATION / NAME	<u> </u>				ESIGN MODEL FILE(S) USED FOR DOCUMENTATION OF 1		PLOT DATE / TIME	PLOT BY	CLIENT		KYOGLE CO		NOT FOR	R CONS	TRUC
PROJECTS\16_BRUXNER HIGHV	WAY\N2019070 Mallanganee Range a	and Willock st \$5390_S5400/DRAWINGS\Final\DS20	· ·	N2019070 HV	W16_MallanganeeRangeWillock_Design_IF	C_V1.txt	11/07/2022 1:12:22	PM tightd	CLIENT	<u> </u>	HW16 - BRU	DUNCIL JXNER HIGHW	/AY		
RAWING FILE LOCATION / NAME IPROJECTS:16_BRUXNER HIGHW XTERNAL REFERENCE FILES	WAY\N2019070 Mallanganee Range a	and Willock st \$5390_\$5400\DRAWINGS\Final\D\$20 REV DATE AMENDMENT / REVISION 0	· ·	N2019070			11/07/2022 1:12:22 TITLE DRAWN DRG CHECK DESIGN DESIGN CHECK	PM tightd NAME D. TIGHT D.JOHNSON D. TIGHT D.JOHNSON D.JOHNSON D.JOHNSON	NSW GOVERNMENT PREPARED FOR REGIONAL MAIN	Transpo for NSW	HW16 - BRU MALLAN 37.52km CROSS 6 HW16 - BRU Trinsw registr	DUNCIL JXNER HIGHW IGANEE RA TO 39.66k SECTIONS JXNER HIGHW RATION NO.	'AY ANGE - WILL m FROM CA	LOCK STRE ASINO 100 TO 39 175 000063	

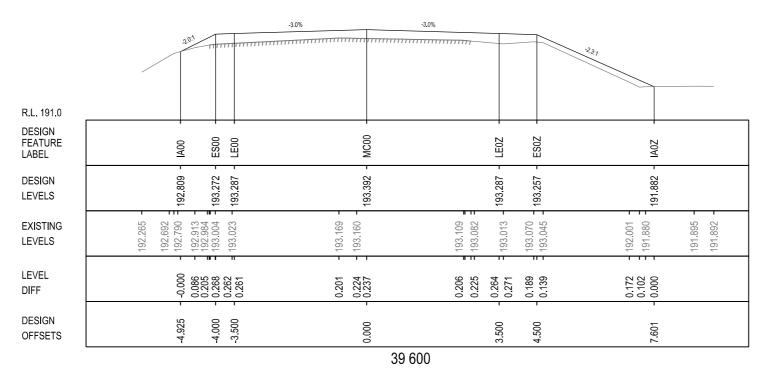


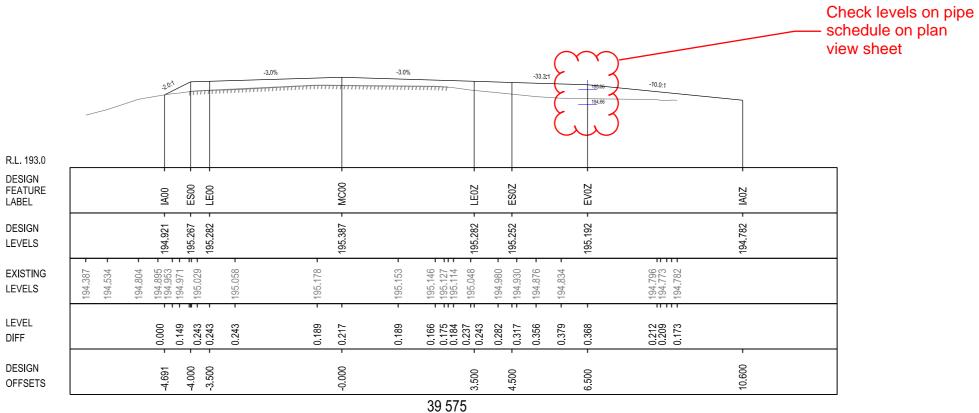


8 8 8												
급 _	DRAWING FILE LOCATION / NAME		DESIGN MODEL FILE(S) USED FOR DOCUMENTATION OF THIS DRAWING HW16_MallanganeeRangeWillock_Design_IFC_V1.txt		PLOT DATE / TIME	PLOT BY	CLIENT	KYOGLE COUNCIL A3				
R 2	K:\PROJECTS\16_BRUXNER HIGHWAY\N2019070 Mallanganee Range and Willock st S5390_S5400\DRAWINGS\FinafiDS2020-000063-04-RC.dgn				11/07/2022 1:12:22 PM tightd			HW16 - BRUXNER HIGHWAY				
BE 02	EXTERNAL REFERENCE FILES REV DATE AMENDMENT / REVISION DESCRIPTION	WVR No. APPROVAL	SCALES ON A3 SIZE DRAWING	DRAWINGS / DESIGN PREPARED BY	TITLE	NAME		MALLANGANEE RANGE - WILLOCK STREET S5390-5400				
¥ <u>"</u>				TRANSPORT FOR NSW	DRAWN	D. TIGHT	Transport	37.52km TO 39.66km FROM CASINO				
∑ £				INFRASTRUCTURE & PLACE ENGINEERING SERVICES	DRG CHECK	D.JOHNSON	KICIM I	CROSS SECTIONS				
Ž₽					DESIGN	D. TIGHT	GOVERNMENT for NSW	HW16 - BRUXNER HIGHWAY - MC00 - 39 200 TO 39 275				
₩ -				ROAD DESIGN NORTHERN	DESIGN CHECK	D.JOHNSON	PREPARED FOR	TRINSW REGISTRATION No. DS2020/000063 PART 1				
□ 5			CO-ORDINATE SYSTEM HEIGHT DATUM	-	DESIGN MANAGER	D.JOHNSON	REGIONAL MAINTENANCE REGIONAL MAINTENANCE DELIVERY NORTHERN					
≌。			MGA ZONE 56 AHD		PROJECT MANAGER	R. GERSERKOWSKI	PROJECT MANAGEMENT NORTHERN	DETAIL DESIGN QA4331765 RC-0028 A				

THIS DRAWING MAY BE PREPARED IN COLOUR AND MAY BE INCOMPLETE IF COPIED 10 15 10 15 20 125 130 135 140 145 150mm on as SZE ORIGINAL

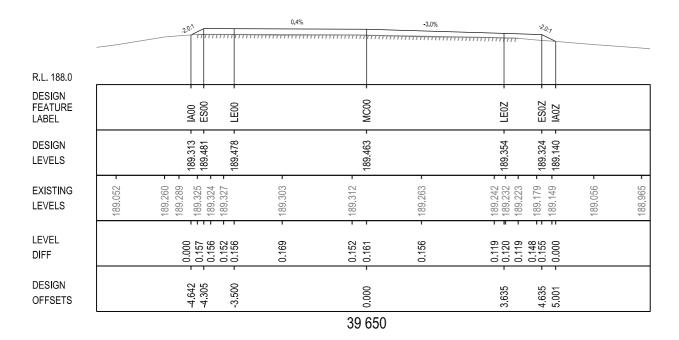

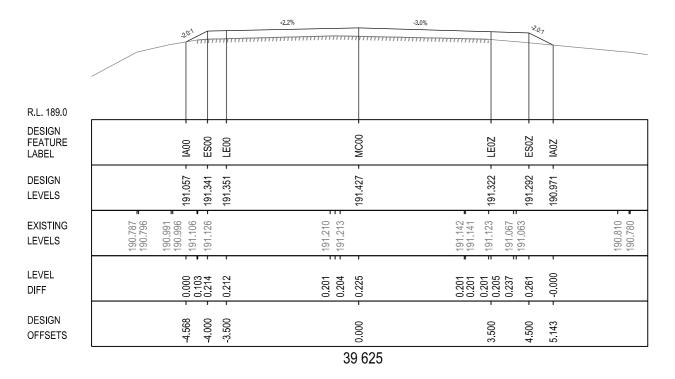

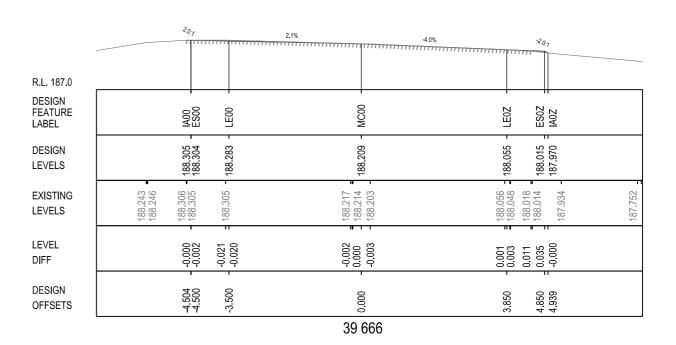

ETE IF COPIED	LEVEL DIFF		0.213	0.201 - 0.225 -		0.201	-0.000	LEVEL DIFF		-0.000		-0.002 -0.000 -0.003	0.001 0.0035 0.0035		
COMPLE	DESIGN OFFSETS	-4.568	-4.000	0.000		3.500	5.143	DESIGN OFFSETS		-4.500 -4.500 -3.500		0.000	3.850 4.850 4.939		
UR AND MAY BE IN				39 625	j							39 666			
REPARED IN COLO 25 30 35 40	DRAWING FILE LOCATION / NAME K:PROJECTS\16 BRUXNER HIGHWAYN2019070 Mall	Jangange Pange and Willing of SE300	SSA00IDDAMINICS\EmailDC2000.		DESIGN LOT CODE N2019070	DESIGN MODEL FILE(S) USED HW16_MallanganeeRai	FOR DOCUMENTATION OF THI DREWIJLOCK DESIGN IFC	s DRAWING V1 1xt	PLOT DATE / TIME 11/07/2022 1:12:2:	PLOT BY B PM tightd	CLIENT		KYOGLE COUNCIL HW16 - BRUXNER HIGHWAY	T FOR CON	ISTRUCTIO
ZE P	EXTERNAL REFERENCE FILES	• •	AMENDMENT / REVISION DESC	•	WVR No. APPROVAL		govviiiooi_booigii_ii o_	DRAWINGS / DESIGN PREPARED BY	TITLE	NAME LIGHTS			MALLANGANEE RANG	F - WILLOCK ST	REET S5390-540
VING MAY E						0 1 2 SCALE 1:100m	3 4	TRANSPORT FOR NSW INFRASTRUCTURE & PLACE ENGINEERING SERVICES	DRAWN DRG CHECK DESIGN	D. TIGHT D.JOHNSON D. TIGHT	NSW GOVERNMENT	Transport for NSW	37.52km TO 39.66km F CROSS SECTIONS HW16 - BRUXNER HIGHWAY - I	ROM CASINO	
THIS DRAW						CO-ORDINATE SYSTEM MGA ZONE 56	HEIGHT DATUM AHD	ROAD DESIGN NORTHERN	DESIGN CHECK DESIGN MANAGER PROJECT MANAGER	D.JOHNSON D.JOHNSON R. GERSERKOWSKI	PREPARED FOR REGIONAL MAINT REGIONAL MAINT PROJECT MANAG	TENANCE TENANCE DELIVERY NORTHERN SEMENT NORTHERN	Trinsw registration No. DS2 I issue status DETAIL DESIGN	020/000063 EDMS No. QA4331765	SHEET No.

NOT FOR CONSTRUCTION Transport

KYOGLE COUNCIL
HW16 - BRUXNER HIGHWAY
MALLANGANEE RANGE - WILLOCK STREET S5390-5400
37.52km TO 39.66km FROM CASINO DESIGN MODEL FILE(S) USED FOR DOCUMENTATION OF THIS DRAWING HW16_MallanganeeRangeWillock_Design_IFC_V1.txt PLOT BY tightd N2019070 11/07/2022 1:12:23 PM K:\PROJECTS\16_BRUXNER HIGHWAY\N2019070 Mallanganee Range and W∎ock st \$5390_\$5400\DRAWINGS\Final\D\$2020-000063-04-RC.dgn EXTERNAL REFERENCE FILES REV DATE AMENDMENT / REVISION DESCRIPTION WVR No. APPROVAL SCALES ON A3 SIZE DRAWING DRAWINGS / DESIGN PREPARED BY TITLE D. TIGHT TRANSPORT FOR NSW DRAWN CROSS SECTIONS HW16 - BRUXNER HIGHWAY - MC00 - 39 400 TO 39 475 4 INFRASTRUCTURE & PLACE DRG CHECK D.JOHNSON for NSW ENGINEERING SERVICES
ROAD DESIGN NORTHERN D. TIGHT DESIGN TfNSW REGISTRATION No. DS2020/000063 DESIGN CHECK D.JOHNSON REGIONAL MAINTENANCE
REGIONAL MAINTENANCE DELIVERY NORTHERN
REGIONAL MAINTENANCE DELIVERY NORTHERN
DETAIL DESIGN D.JOHNSON DESIGN MANAGER CO-ORDINATE SYSTEM MGA ZONE 56 HEIGHT DATUM AHD RC-0030 PROJECT MANAGER R. GERSERKOWSKI © Transport for NSW

NOT FOR CONSTRUCTION Transport

KYOGLE COUNCIL
HW16 - BRUXNER HIGHWAY
MALLANGANEE RANGE - WILLOCK STREET S5390-5400
37.52km TO 39.66km FROM CASINO DESIGN MODEL FILE(S) USED FOR DOCUMENTATION OF THIS DRAWING HW16_MallanganeeRangeWillock_Design_IFC_V1.txt PLOT BY tightd N2019070 11/07/2022 1:12:23 PM K:\PROJECTS\16_BRUXNER HIGHWAY\N2019070 Mallanganee Range and W∎ock st \$5390_\$5400\DRAWINGS\Final\D\$2020-000063-04-RC.dgn EXTERNAL REFERENCE FILES REV DATE AMENDMENT / REVISION DESCRIPTION WVR No. APPROVAL SCALES ON A3 SIZE DRAWING DRAWINGS / DESIGN PREPARED BY TITLE D. TIGHT TRANSPORT FOR NSW DRAWN CROSS SECTIONS HW16 - BRUXNER HIGHWAY - MC00 - 39 500 TO 39 550 4 INFRASTRUCTURE & PLACE DRG CHECK D.JOHNSON for NSW ENGINEERING SERVICES
ROAD DESIGN NORTHERN D. TIGHT DESIGN TfNSW REGISTRATION No. DS2020/000063 DESIGN CHECK D.JOHNSON REGIONAL MAINTENANCE
REGIONAL MAINTENANCE DELIVERY NORTHERN
REGIONAL MAINTENANCE DELIVERY NORTHERN
DETAIL DESIGN D.JOHNSON DESIGN MANAGER CO-ORDINATE SYSTEM MGA ZONE 56 HEIGHT DATUM AHD SHEET No. RC-0031 PROJECT MANAGER R. GERSERKOWSKI © Transport for NSW

200mm

NOT FOR CONSTRUCTION


Transport


KYOGLE COUNCIL
HW16 - BRUXNER HIGHWAY
MALLANGANEE RANGE - WILLOCK STREET S5390-5400
37.52km TO 39.66km FROM CASINO
CROSS SECTIONS DESIGN MODEL FILE(S) USED FOR DOCUMENTATION OF THIS DRAWING HW16_MallanganeeRangeWillock_Design_IFC_V1.txt PLOT BY tightd 11/07/2022 1:12:24 PM N2019070 K:\PROJECTS\16_BRUXNER HIGHWAY\N2019070 Mallanganee Range and W∎ock st \$5390_\$5400\DRAWINGS\Final\D\$2020-000063-04-RC.dgn EXTERNAL REFERENCE FILES REV DATE AMENDMENT / REVISION DESCRIPTION WVR No. APPROVAL SCALES ON A3 SIZE DRAWING DRAWINGS / DESIGN PREPARED BY TITLE D. TIGHT TRANSPORT FOR NSW DRAWN CROSS SECTIONS HW16 - BRUXNER HIGHWAY - MC00 - 39 575 TO 39 650 4 INFRASTRUCTURE & PLACE DRG CHECK D.JOHNSON for NSW ENGINEERING SERVICES ROAD DESIGN NORTHERN D. TIGHT DESIGN TfNSW REGISTRATION No. DS2020/000063 DESIGN CHECK D.JOHNSON REGIONAL MAINTENANCE
REGIONAL MAINTENANCE DELIVERY NORTHERN SSUE STATUS
PROJECT MANAGEMENT NORTHERN DETAIL DESIGN D.JOHNSON CO-ORDINATE SYSTEM MGA ZONE 56 DESIGN MANAGER HEIGHT DATUM AHD PROJECT MANAGER R. GERSERKOWSKI

RC-0032 © Transport for NSW


NOT FOR CONSTRUCTION Transport

KYOGLE COUNCIL
HW16 - BRUXNER HIGHWAY
MALLANGANEE RANGE - WILLOCK STREET S5390-5400
37.52km TO 39.66km FROM CASINO
CROSS SECTIONS DESIGN MODEL FILE(S) USED FOR DOCUMENTATION OF THIS DRAWING HW16_MallanganeeRangeWillock_Design_IFC_V1.txt PLOT BY tightd 11/07/2022 1:12:24 PM N2019070 K:\PROJECTS\16_BRUXNER HIGHWAY\N2019070 Mallanganee Range and W∎ock st \$5390_\$5400\DRAWINGS\Final\D\$2020-000063-04-RC.dgn EXTERNAL REFERENCE FILES REV DATE AMENDMENT / REVISION DESCRIPTION WVR No. APPROVAL SCALES ON A3 SIZE DRAWING DRAWINGS / DESIGN PREPARED BY TITLE D. TIGHT TRANSPORT FOR NSW DRAWN CROSS SECTIONS HW16 - BRUXNER HIGHWAY - MC00 - 39 666 4 INFRASTRUCTURE & PLACE DRG CHECK D.JOHNSON for NSW ENGINEERING SERVICES
ROAD DESIGN NORTHERN D. TIGHT DESIGN TfNSW REGISTRATION No. DS2020/000063 DESIGN CHECK D.JOHNSON REGIONAL MAINTENANCE
REGIONAL MAINTENANCE DELIVERY NORTHERN
REGIONAL MAINTENANCE DELIVERY NORTHERN
DETAIL DESIGN D.JOHNSON DESIGN MANAGER CO-ORDINATE SYSTEM MGA ZONE 56 HEIGHT DATUM AHD RC-0033 PROJECT MANAGER R. GERSERKOWSKI

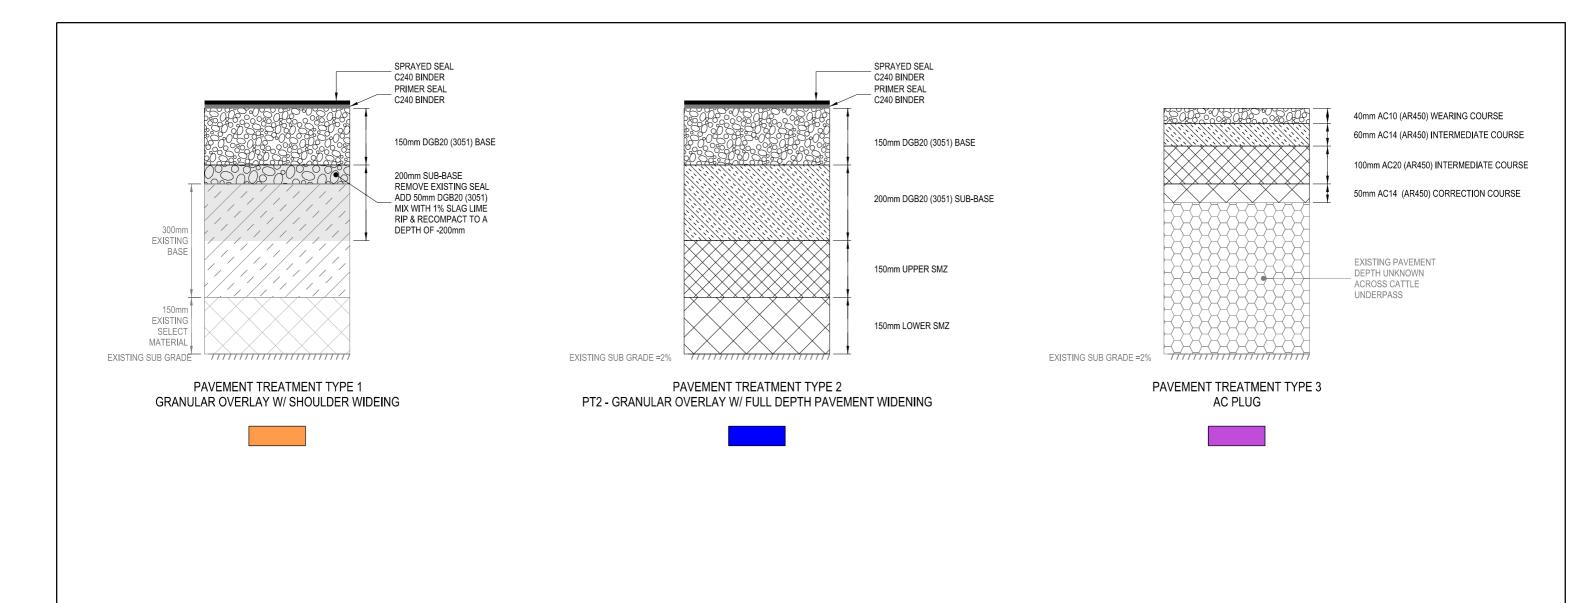

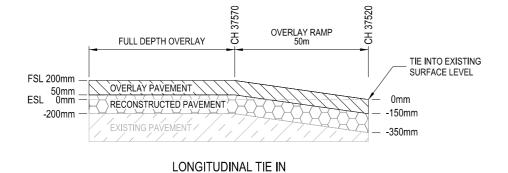

EASTERN LIMIT OF WORKS

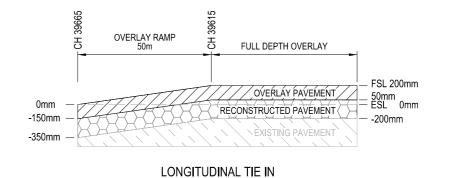



WESTERN LIMIT OF WORKS


ACCEPTION FOR CONSTRUCTION


© Transport for NSW


KYOGLE COUNCIL HW16 - BRUXNER HIGHWAY DESIGN MODEL FILE(S) USED FOR DOCUMENTATION OF THIS DRAWING 11/07/2022 1:12:25 PM CIPROJECTS\16_BRUXNER HIGHWAY\N2019070 Mallanganee Range and W≣ock st \$5390_S5400\DRAWINGS\Final\DS2020-000063-07-PV.dgn N2019070 HW16_MallanganeeRangeWillock_Design_IFC_V1.txt tightd Transport MALLANGANEE RANGE - WILLOCK STREET S5390-5400 37.52km TO 39.66km FROM CASINO AMENDMENT / REVISION DESCRIPTION WVR No. | APPROVAL | SCALES ON A3 SIZE DRAWING DRAWINGS / DESIGN PREPARED BY EXTERNAL REFERENCE FILES REV DATE NAME TITLE D. TIGHT TRANSPORT FOR NSW DRAWN PAVEMENT PLAN
PAVEMENT PROFILES INFRASTRUCTURE & PLACE DRG CHECK D.JOHNSON for NSW NOT TO SCALE ENGINEERING SERVICES D. TIGHT DESIGN ROAD DESIGN NORTHERN DESIGN CHECK D.JOHNSON TfNSW REGISTRATION No. DS2020/000063 REGIONAL MAINTENANCE
REGIONAL MAINTENANCE DELIVERY NORTHERN ISSUE STATUS
PROJECT MANAGEMENT NORTHERN DETAIL DES D.JOHNSON DESIGN MANAGER CO-ORDINATE SYSTEM HEIGHT DATUM PV-0001 MGA ZONE 56 AHD R. GERSERKOWSKI DETAIL DESIGN

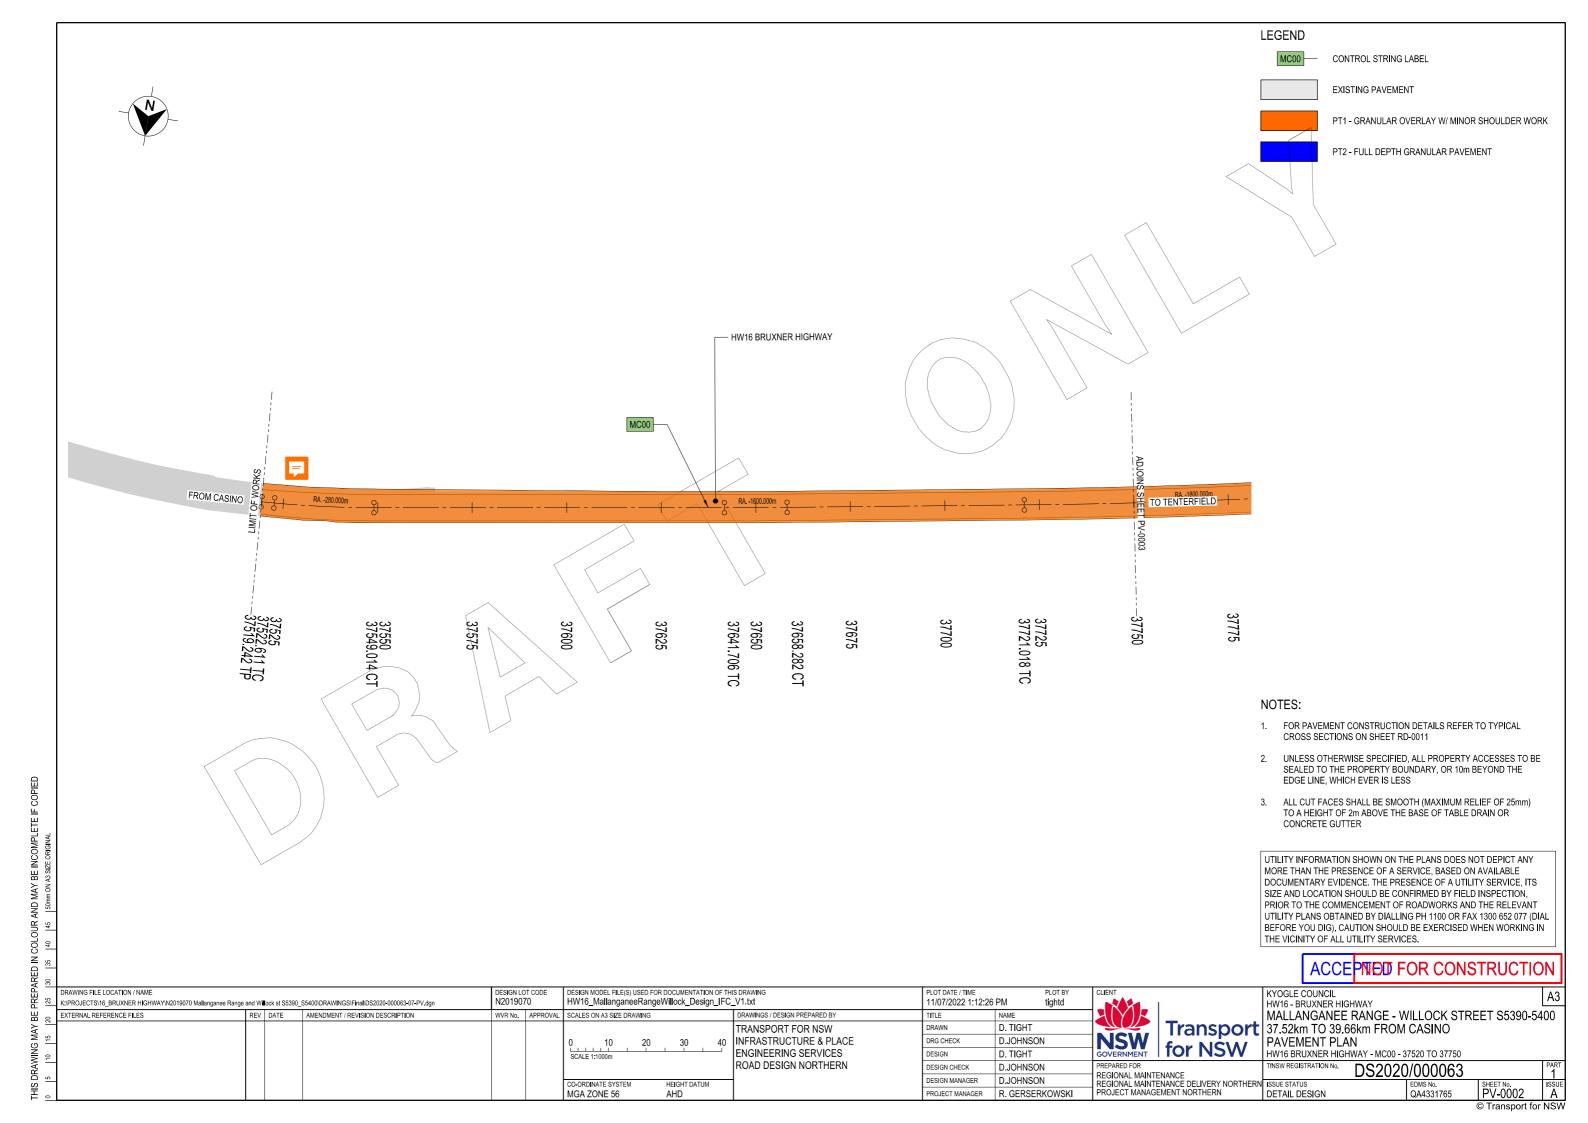


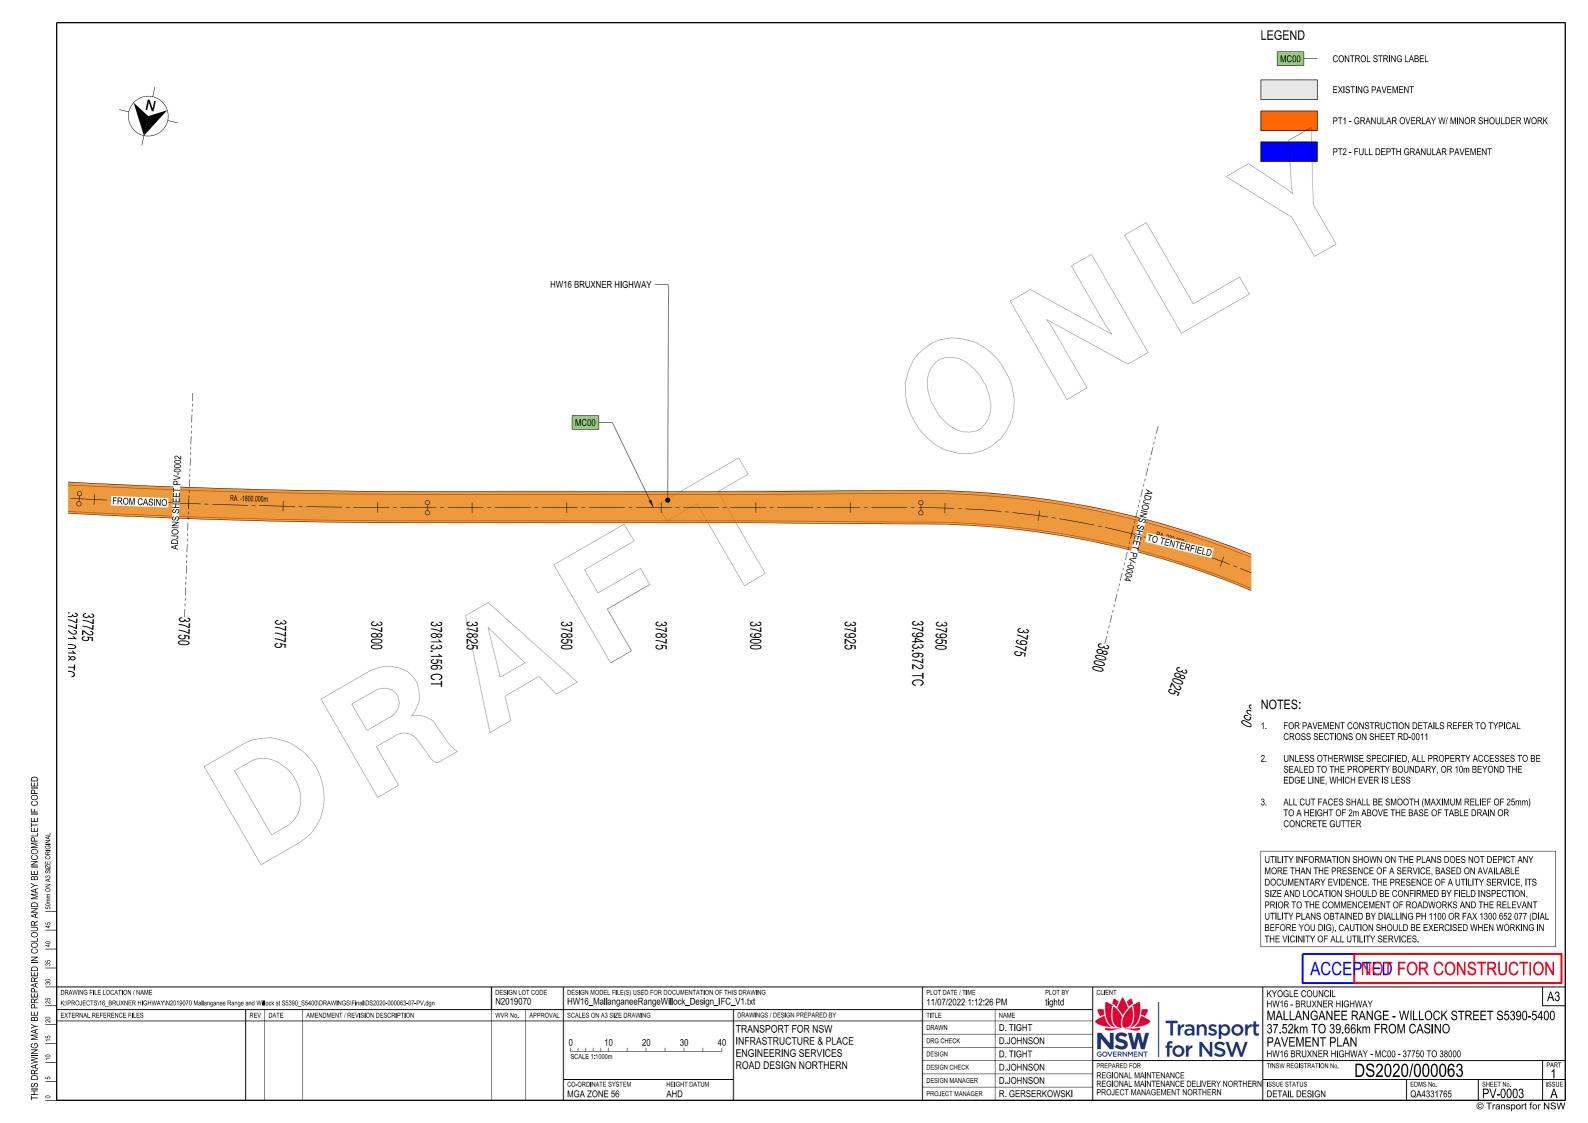


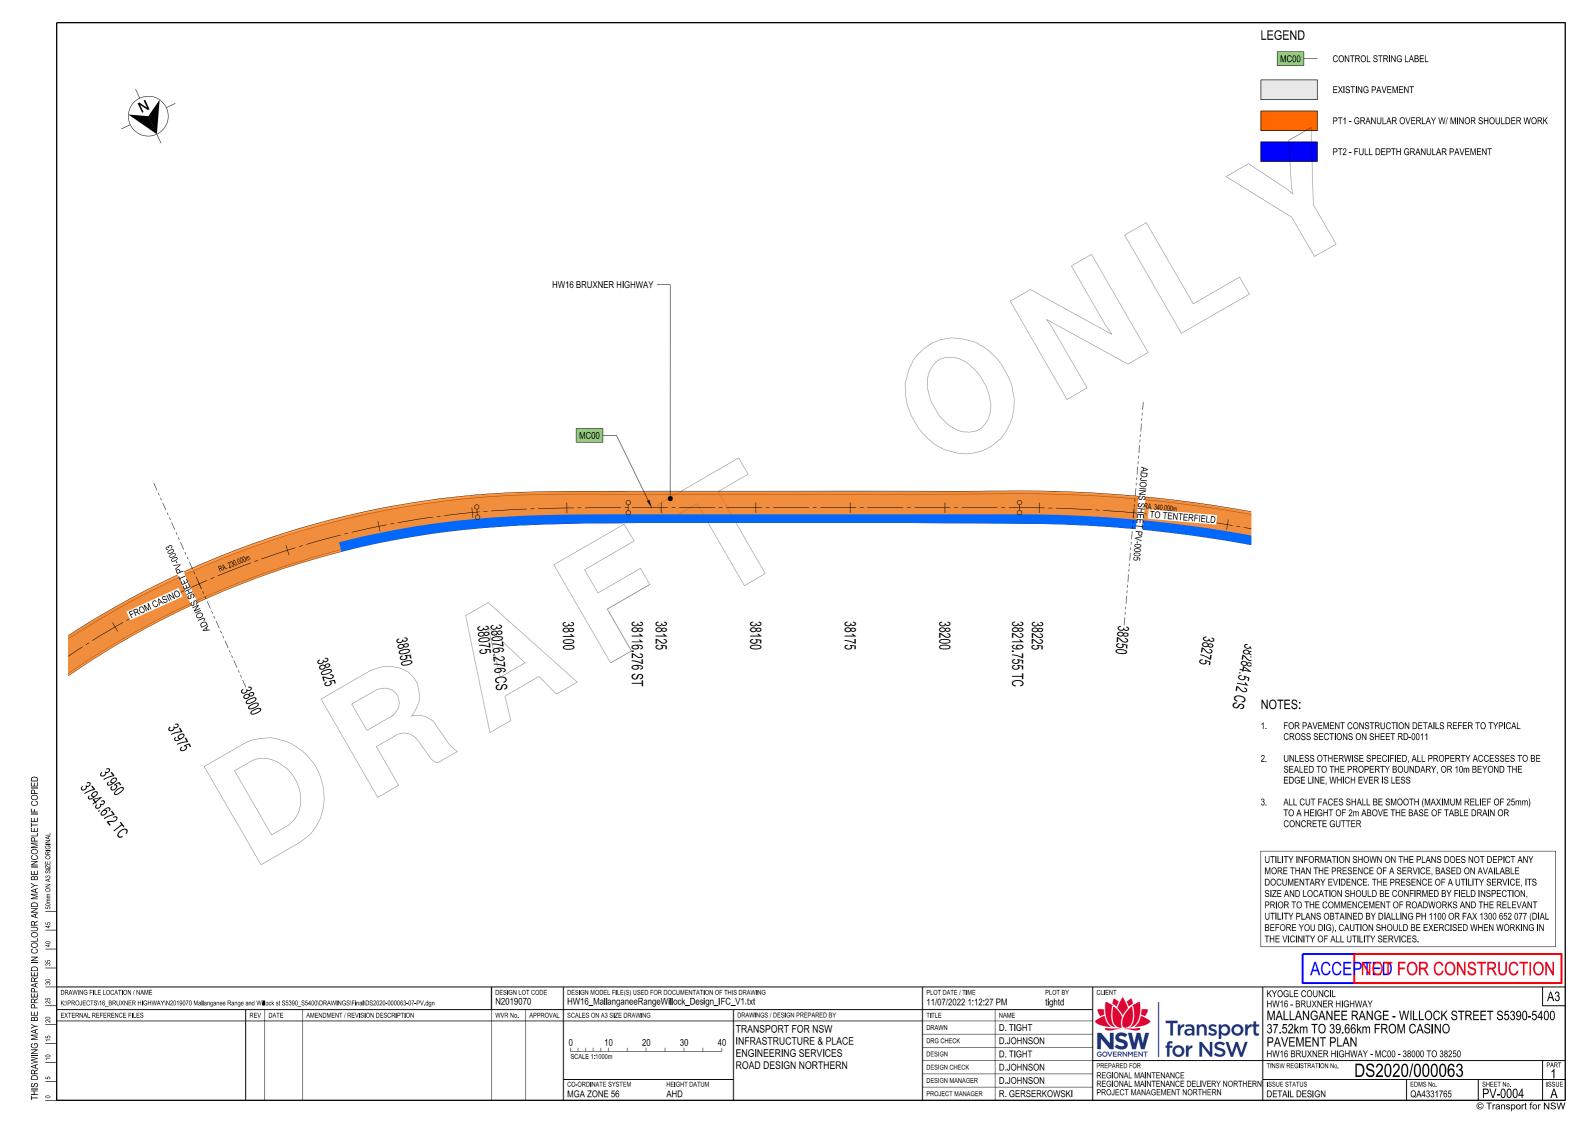


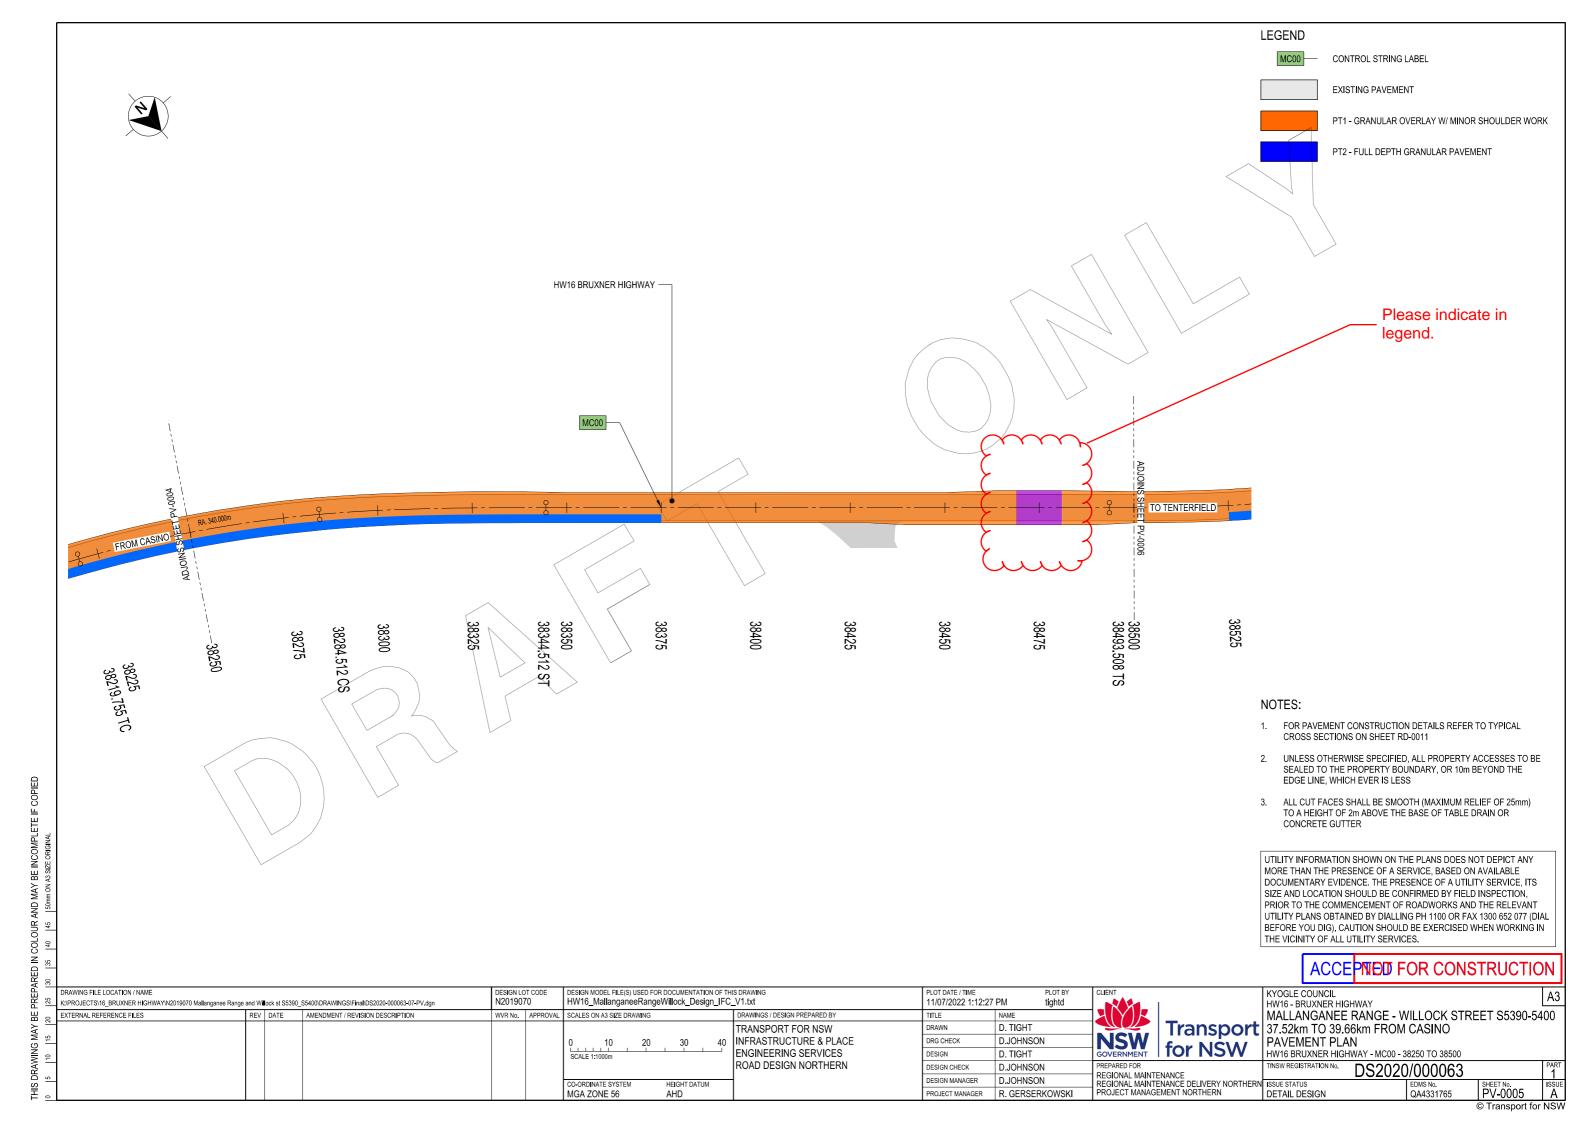


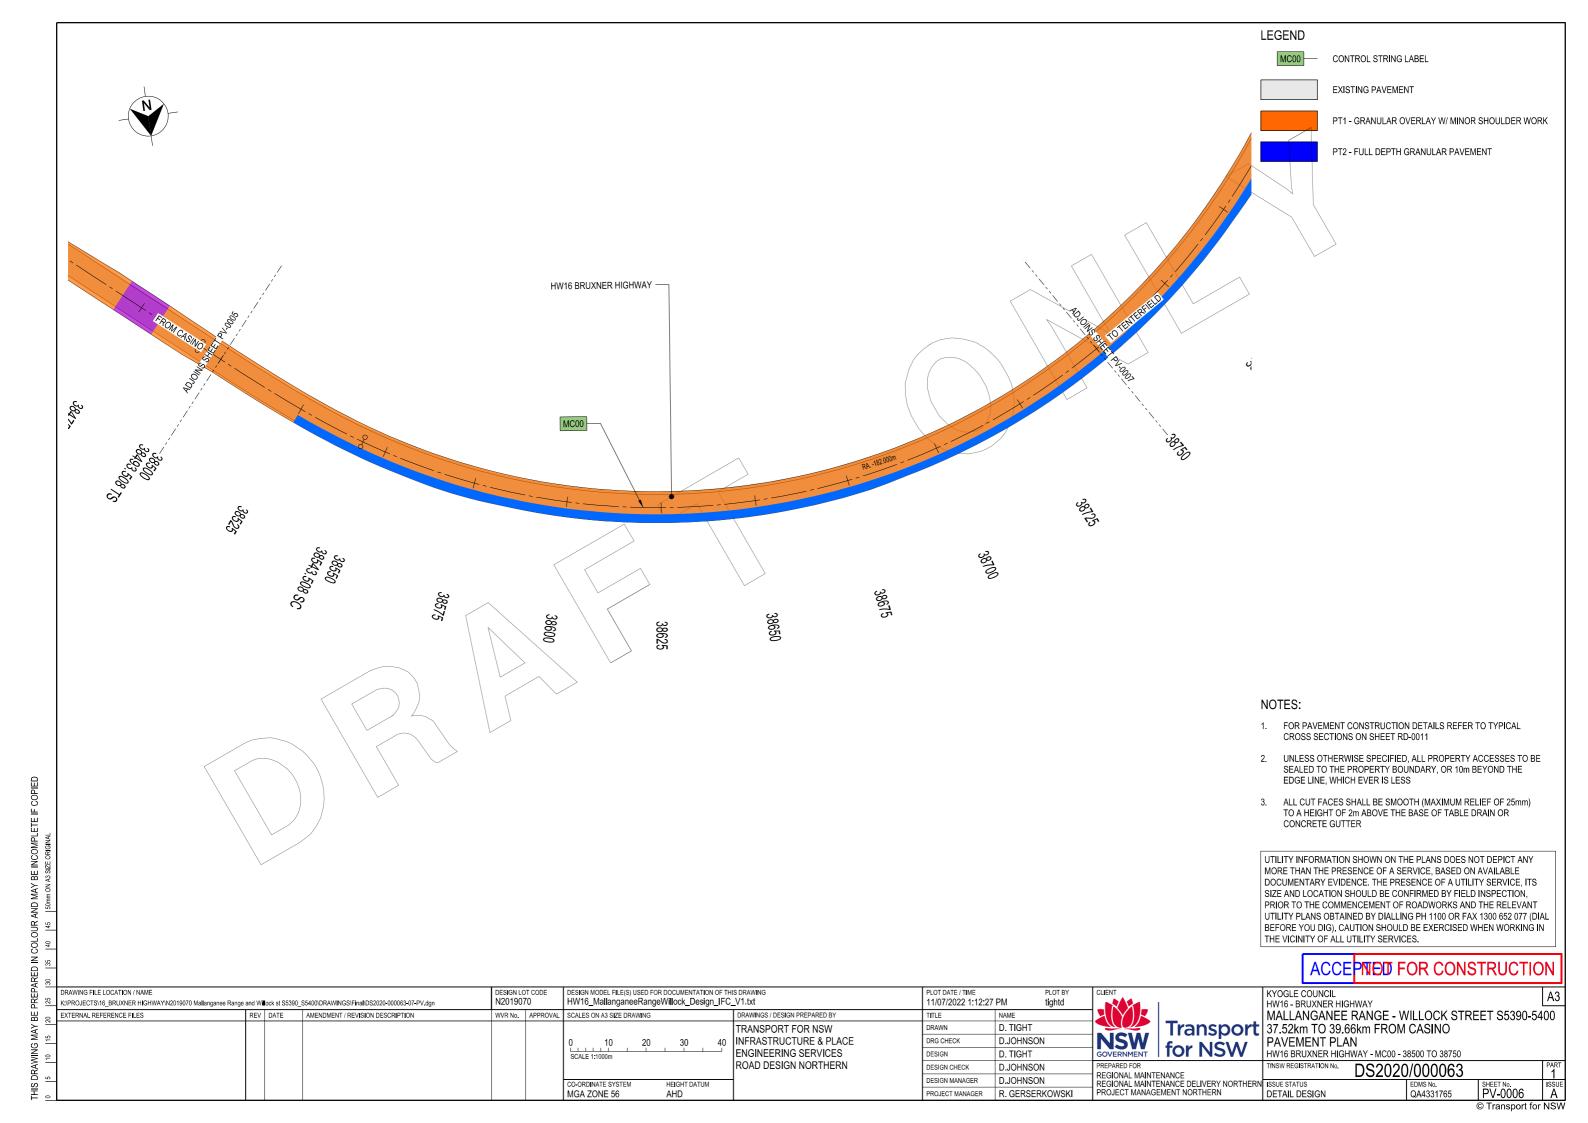

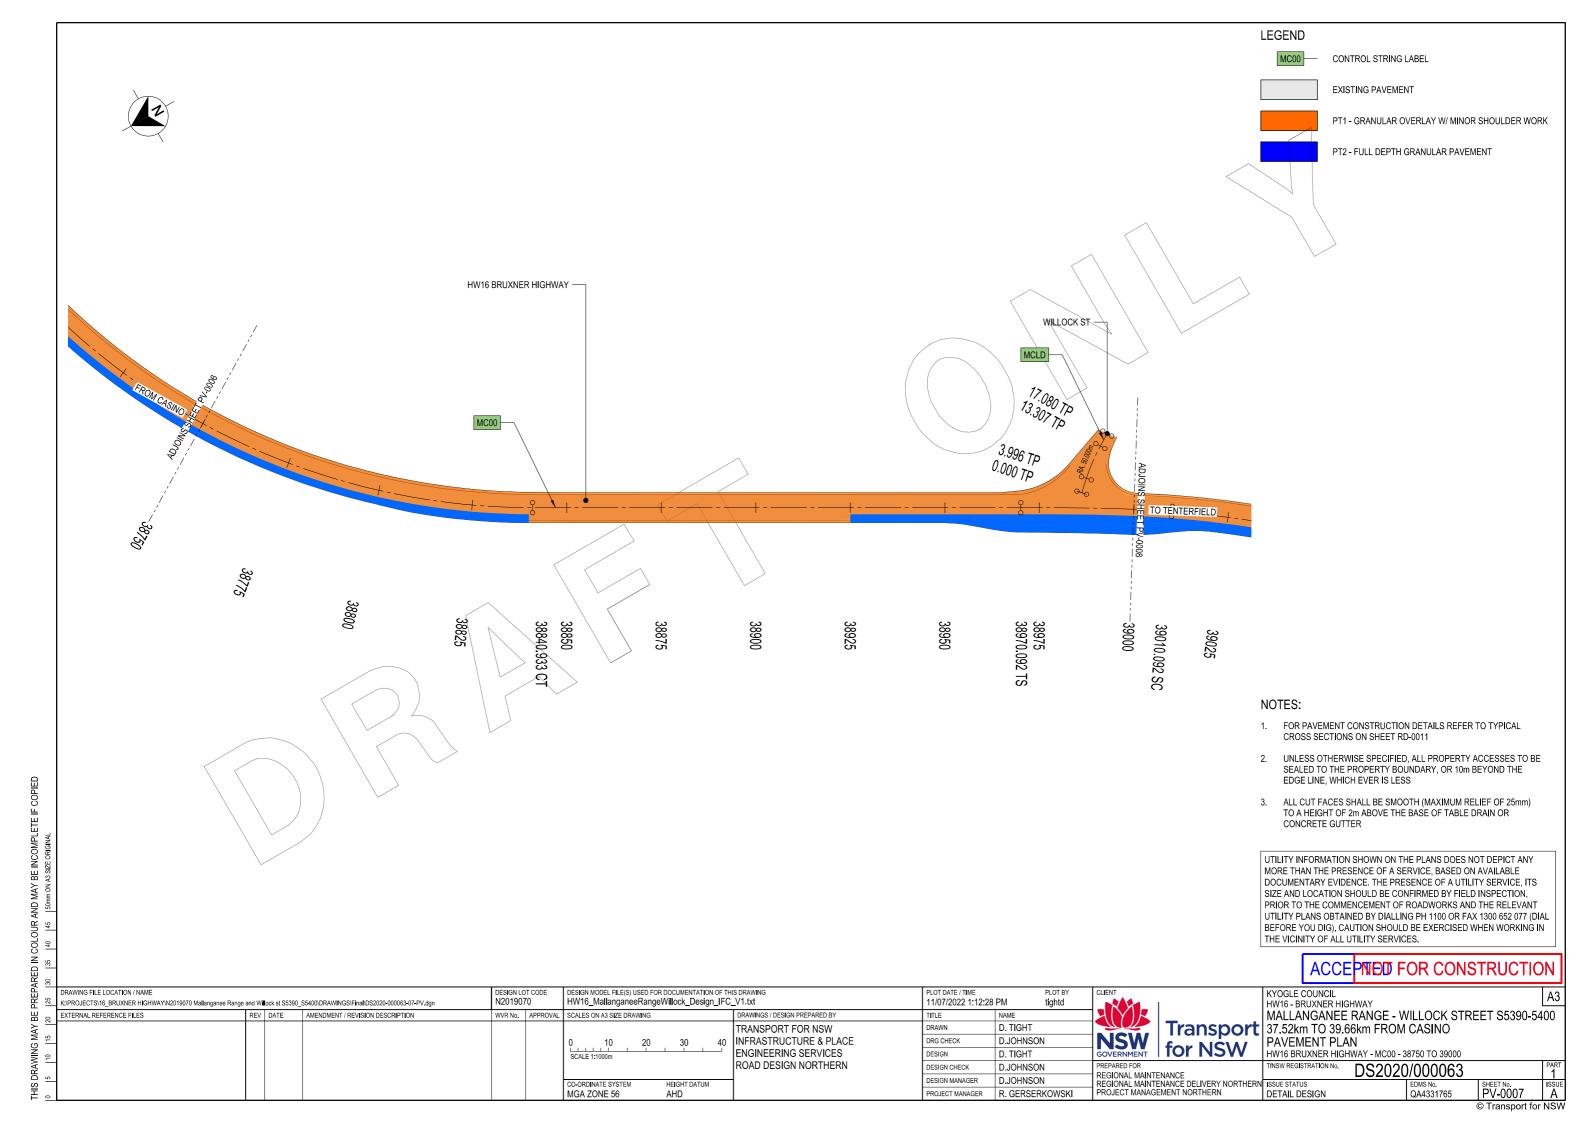

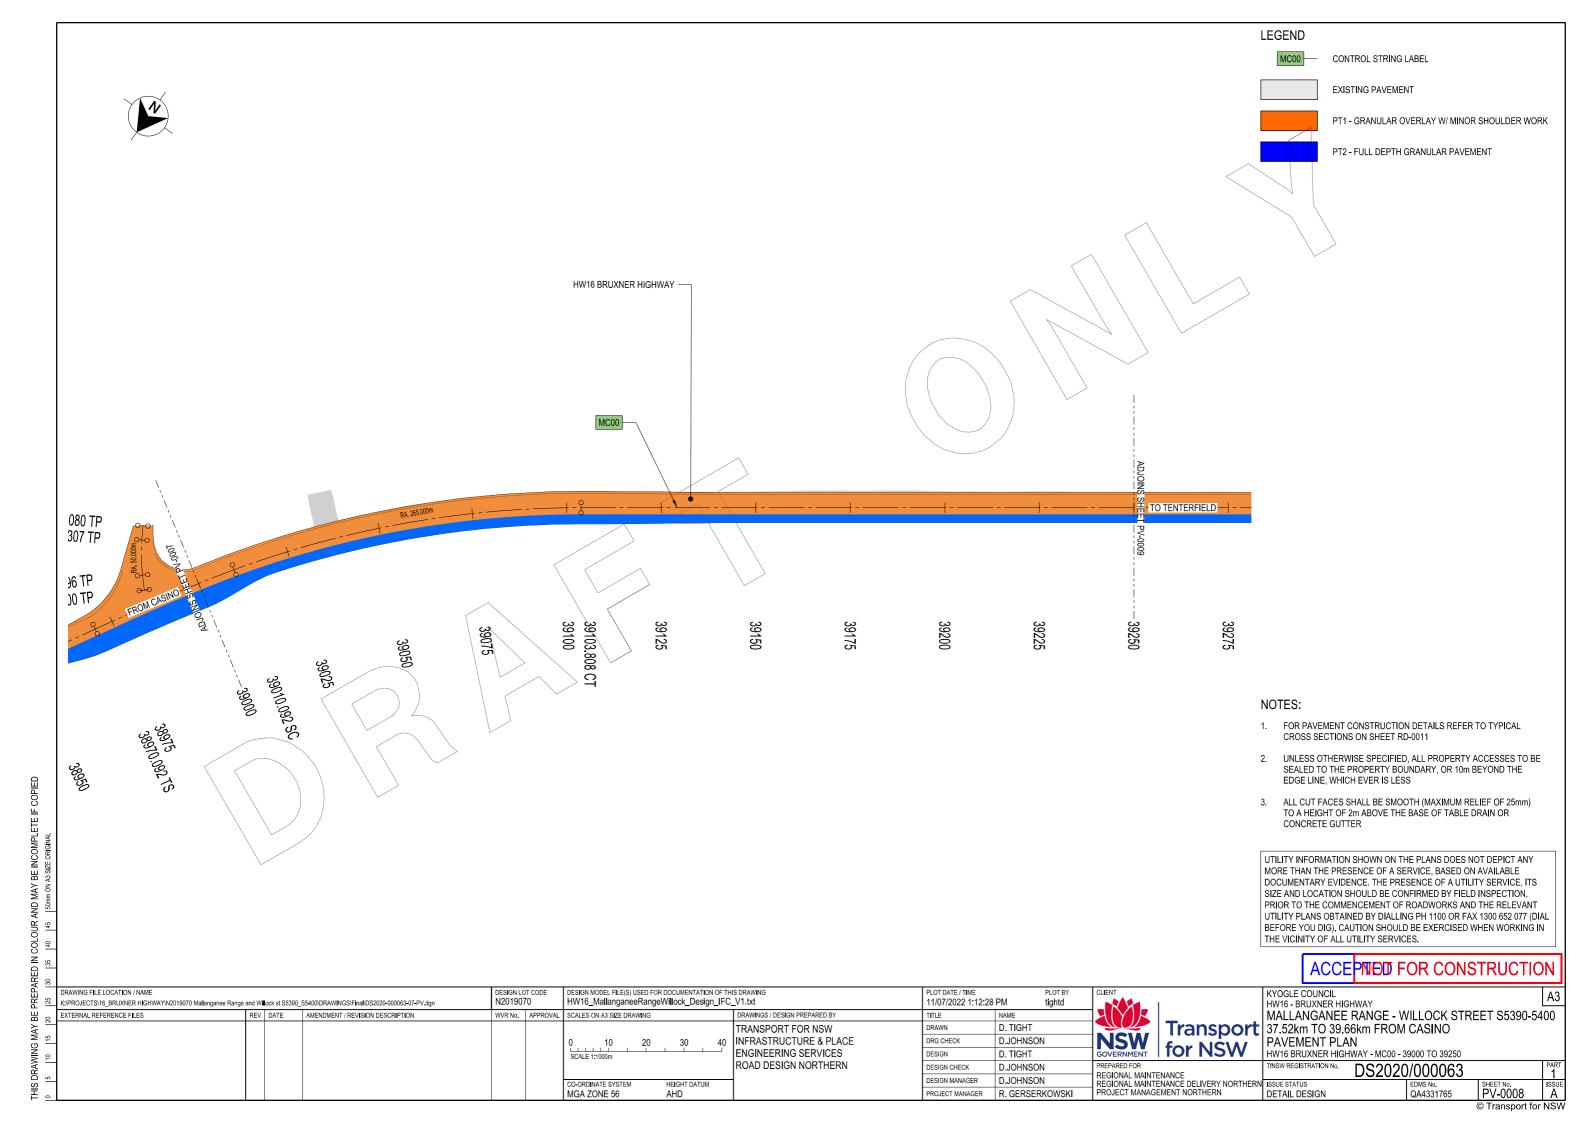

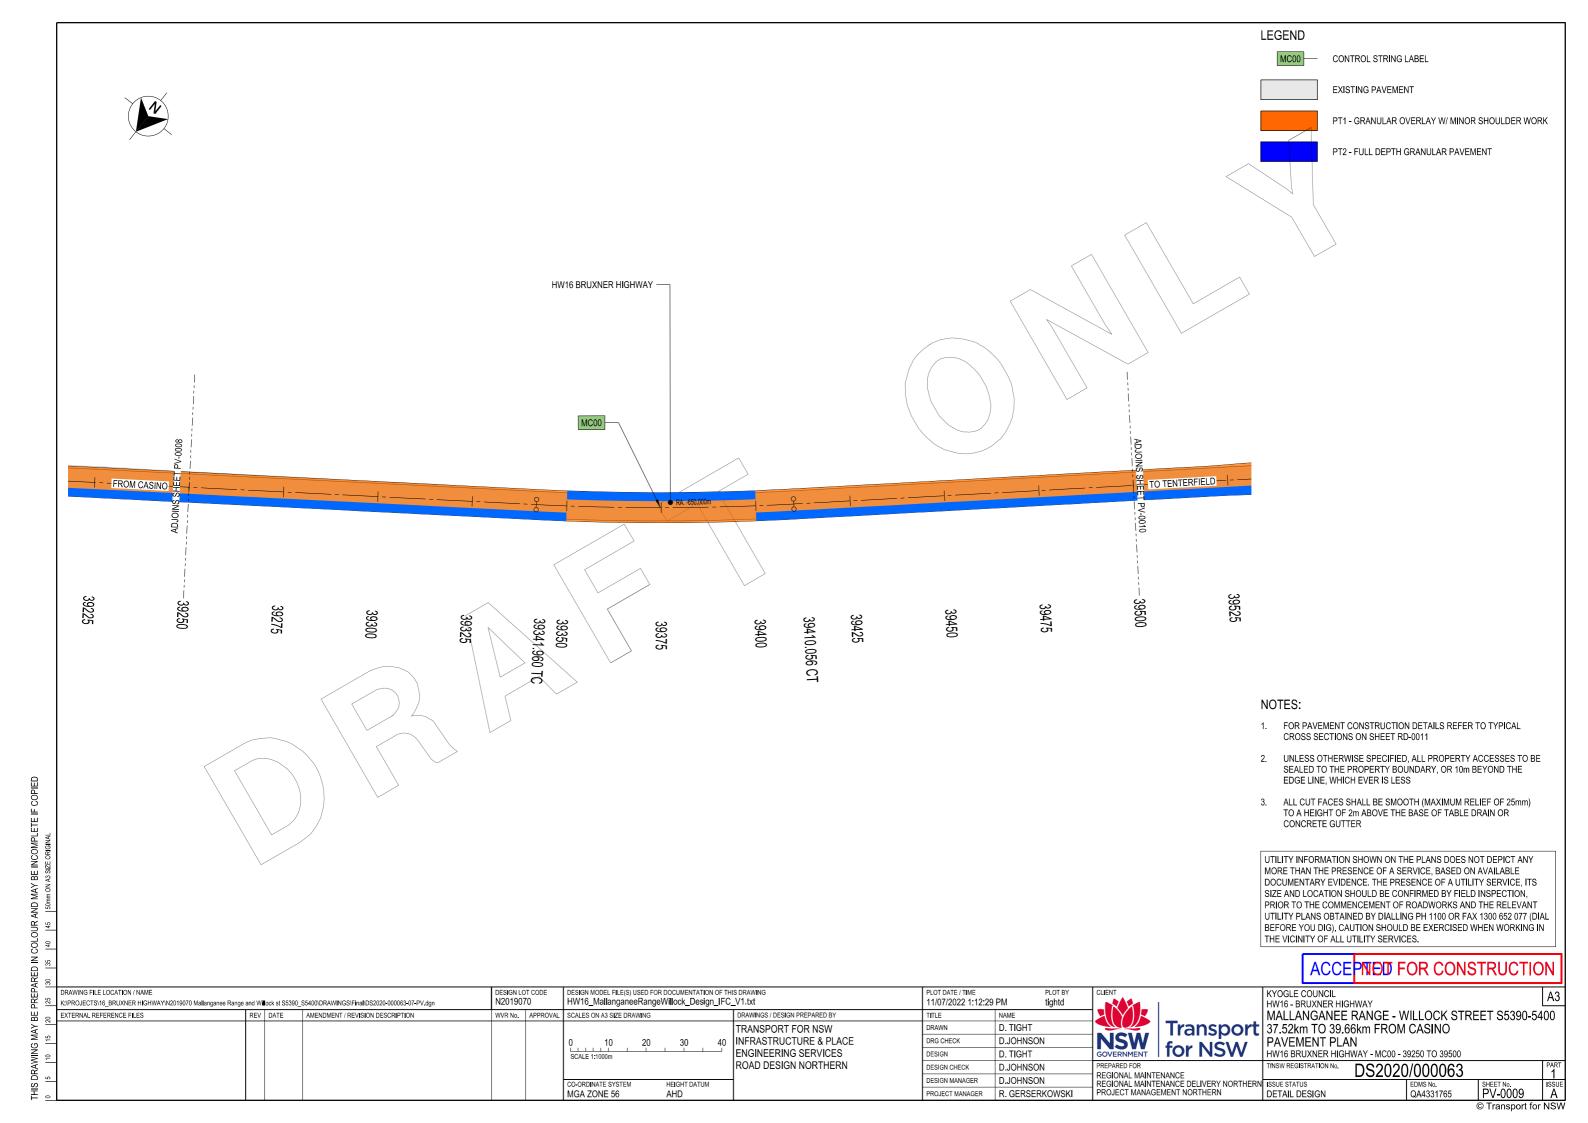

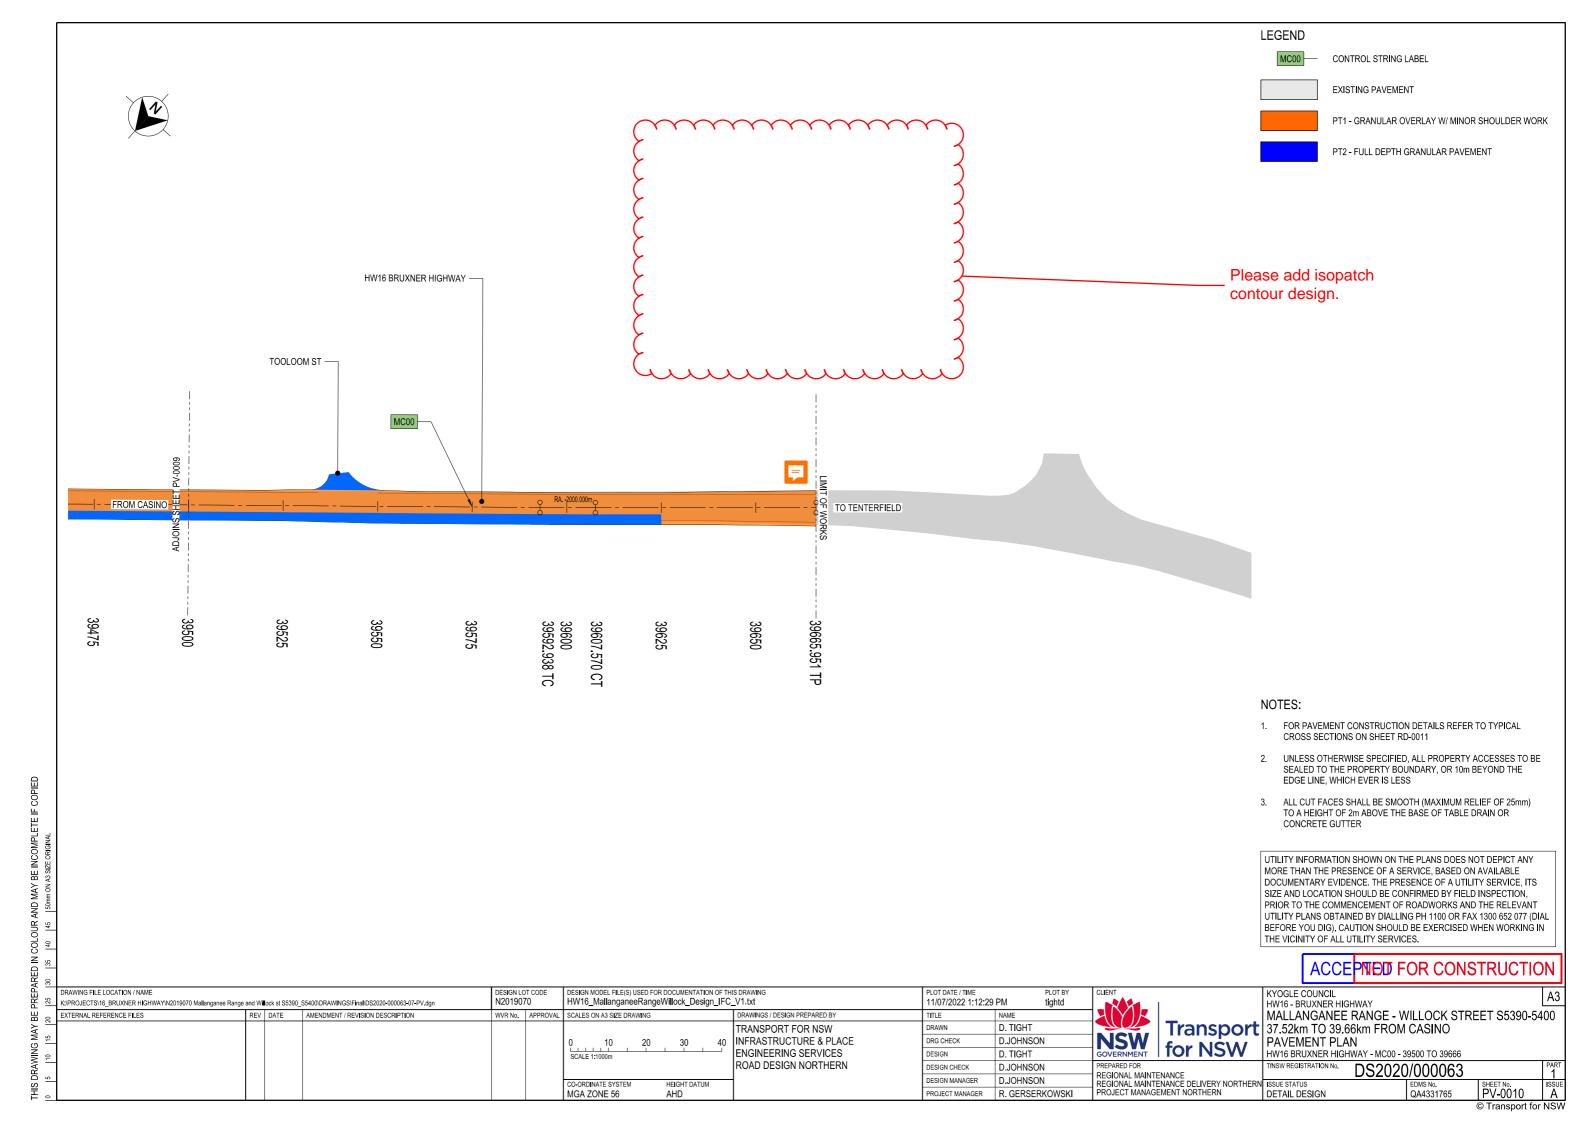

BARRIER SCHEDULE

IDENTIFICATION	TYPE	SHEET NO.	LENGTH (m)		STAR	Т		FINISI	Н
IDEIVIII IO/VIIOIV	'''-	ONLET NO.	LENGTH (III)	CONTROL	CHAINAGE	TERMINAL / TRANSITION	CONTROL	CHAINAGE	TERMINAL / TRANSITION
SB01	SENTRY TL3 W-BEAM LONG POST	RF-0002-0004	420	MC00	37930	SENTRY - MAX TENSION	MC00	38350	SENTRY - MAX TENSION
SB02	SENTRY TL3 W-BEAM LONG POST	RF-0004-0006	405	MC00	38445	SENTRY - MAX TENSION	MC00	38850	SENTRY - MAX TENSION
SB03	SENTRY TL3 W-BEAM LONG POST	RF-0004	60	MC00	38440	SENTRY - MAX TENSION	MC00	38500	SENTRY - MAX TENSION
SB04	SENTRY TL3 W-BEAM LONG POST	RF-0010	101	MC00	39565	SENTRY - MAX TENSION	MC00	39666	SENTRY - MAX TENSION

NEW SIGNPOSTING SCHEDULE


A.S. REF NUMBER	SIGN FACE	SIZE	CHAINAGE	DIRECTION	INSTALLATION
W1-3 (R)	*	Α	38150	WEST BOUND LANE	SINGLE POST
W8-2 (85)	85 km/h	А	38150	WEST BOUND LANE	SINGLE POST
W1-3 (L)	◆	А	38360	EAST BOUND LANE	SINGLE POST
W8-2 (85)	85 km/h	А	38360	EAST BOUND LANE	SINGLE POST
D4-1-1	*****	A x2	38985	WEST BOUND LANE LONGITUDINAL	DOUBLE POST x2

LINEMARKING SCHEDULE

TYPE	LENGTH (m)	STA	\RT	FIN	ISH
ITFE	LENGTH (III)	CONTROL	CHAINAGE	CONTROL	CHAINAGE
E1 (L)	1451	MC00	37519	MC00	38970
E1 (R)	2147	MC00	37519	MC00	39666
C1	30	MC00	38970	MC00	39000
E1 (L)	533	MC00	39000	MC00	39533
C1	17	MC00	39533	MC00	39550
E1 (L)	116	MC00	39550	MC00	39666
BS1 (L)	123	MC00	37519	MC00	37642
S1	153	MC00	37642	MC00	37795
BS1 (R)	195	MC00	37795	MC00	37990
BB1	70	MC00	37990	MC00	38060
BS1 (L)	165	MC00	38060	MC00	38225
S1	235	MC00	38225	MC00	38460
BB1	518	MC00	38460	MC00	38978
BB1	43	MC00	38992	MC00	39035
BS1 (L)	80	MC00	39035	MC00	39115
S1	185	MC00	39115	MC00	39300
BS1 (R)	60	MC00	39300	MC00	39360
BB1	173	MC00	39360	MC00	39533
BB1	121	MC00	39545	MC00	39666

NOT FOR CONSTRUCTION

PREP/	DRAWING FILE LOCATION / NAME K:\PROJECTS\16_BRUXNER HIGHWAY\N2019070 Mallanganee Range	// IN2019070 Mallanganee Range and Willock st S5390_S5400/DRAWINGS/Final/DS2020-000063-08-RF.dgn REV DATE AMENDMENT / REVISION DESCRIPTION			DESIGN MODEL FILE(S) USED F HW16_MallanganeeRang			PLOT DATE / TIME 11/07/2022 1:12:30	PLOT BY D PM tightd	CLIENT	I	KYOGLE COUNCIL HW16 - BRUXNER HIGHWA			A3
BE 03	EXTERNAL REFERENCE FILES	REV DATE	AMENDMENT / REVISION DESCRIPTION	WVR No. APPROVAL	SCALES ON A3 SIZE DRAWING		DRAWINGS / DESIGN PREPARED BY	TITLE	NAME	XIYIR			NGE - WILLOCK STR	EET S5390-54	,400
¥ =	1						TRANSPORT FOR NSW	DRAWN	D. TIGHT		Transport	37.52km TO 39.66kn	n FROM CASINO		
S M	1						INFRASTRUCTURE & PLACE	DRG CHECK	D.JOHNSON	NSW		ROADSIDE FURNIT	URE PLAN		
ĕ º							ENGINEERING SERVICES	DESIGN	D. TIGHT	GOVERNMENT		ROAD FURNITURE AND LIN			
	1						ROAD DESIGN NORTHERN	DESIGN CHECK	D.JOHNSON	PREPARED FOR		TfNSW REGISTRATION No.	S2020/000063		PART
5 5	4				CO-ORDINATE SYSTEM	HEIGHT DATUM	-	DESIGN MANAGER	D.JOHNSON	REGIONAL MAINT	ENANCE ENANCE DELIVERY NORTHERN		EDMS No.	SHEET No.	ISSUE
Ĕ.					MGA ZONE 56	AHD		PROJECT MANAGER	R. GERSERKOWSKI		EMENT NORTHERN	DETAIL DESIGN	QA4331765	RF-0001	Ä
. –	-							•		•				© Transport for	r NSW

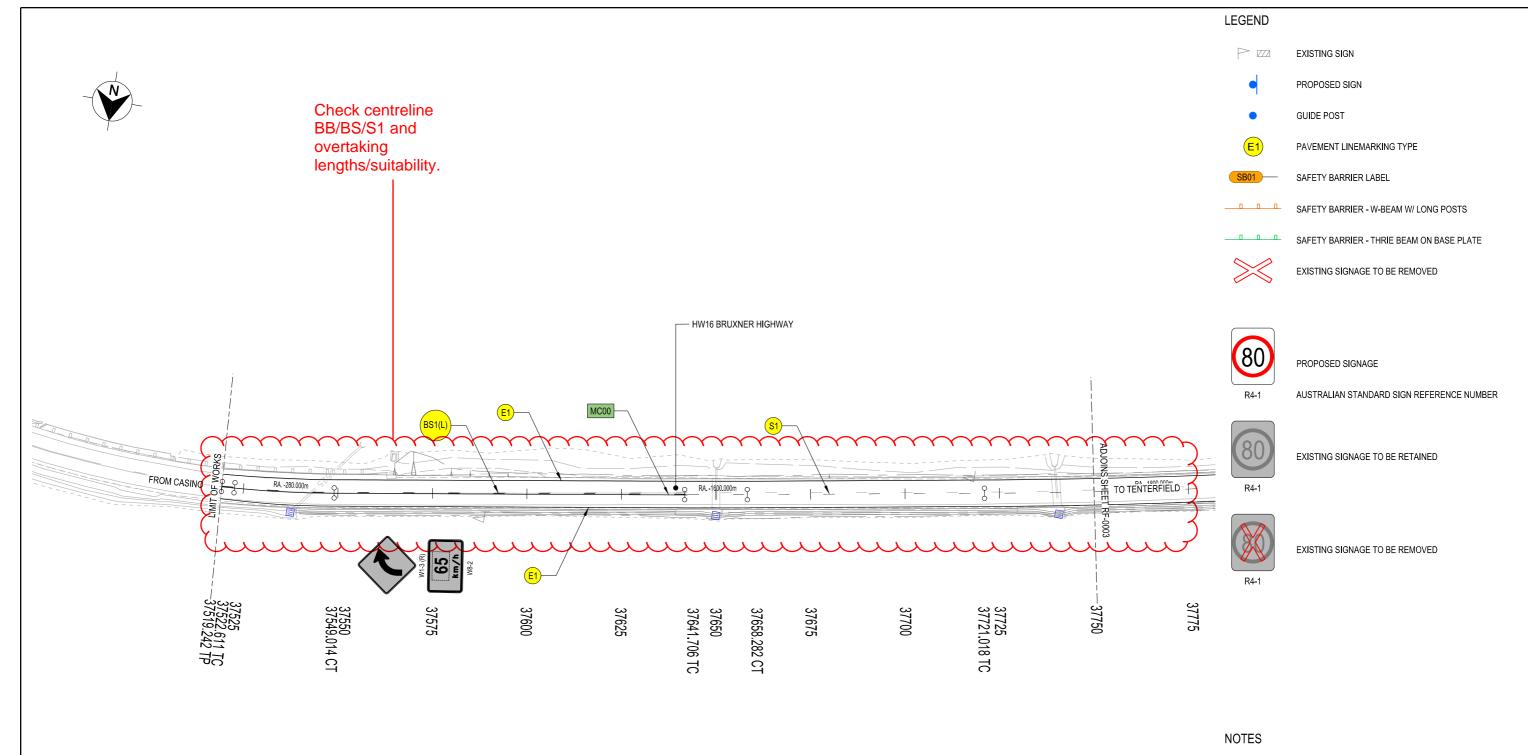

- ALL DELINEATION TO BE IN ACCORDANCE WITH ROADS AND MARITIME SERVICES DELINEATION MANUAL
- SIGN POSTING TO BE INSTALLED IN ACCORDANCE WITH ROADS AND MARITIME DOCUMENT "INSTALLATION AND MAINTENANCE OF SIGNS" AND AS1742

UTILITY INFORMATION SHOWN ON THE PLANS DOES NOT DEPICT ANY MORE THAN THE PRESENCE OF A SERVICE, BASED ON AVAILABLE DOCUMENTARY EVIDENCE. THE PRESENCE OF A UTILITY SERVICE, ITS SIZE AND LOCATION SHOULD BE CONFIRMED BY FIELD INSPECTION, PRIOR TO THE COMMENCEMENT OF ROADWORKS AND THE RELEVANT UTILITY PLANS OBTAINED BY DIALLING PH 1100 OR FAX 1300 652 077 (DIAL BEFORE YOU DIG). CAUTION SHOULD BE EXERCISED WHEN WORKING IN THE VICINITY OF ALL UTILITY SERVICES.


NOT FOR CONSTRUCTION

				_									
AWING FILE LOCATION / NAME ROJECTS\16_BRUXNER HIGHWAY\N2019070 Mallanganee Range and Willock st \$5390_S5400\DRAWINGS\Final\DS2020-000063-08-RF.dgn TERNAL REFERENCE FILES REV DATE AMENDMENT / REVISION DESCRIPTION			N201907		DESIGN MODEL FILE(S) USED FOR DOCUMENTATION OF THE HW16_MallanganeeRangeWillock_Design_IFC		PLOT DATE / TIME PLOT BY 11/07/2022 1:12:33 PM tightd			CLIENT	1	KYOGLE CO HW16 - BRU	
EXTERNAL REFERENCE FILES	REV	DATE	AMENDMENT / REVISION DESCRIPTION	WVR No.	APPROVAL	SCALES ON A3 SIZE DRAWING	DRAWINGS / DESIGN PREPARED BY	TITLE	NAME		XIXIK		MALLAN
1							TRANSPORT FOR NSW	DRAWN	D. TIGHT			Transport	37.52km
1						0 10 20 30 40	INFRASTRUCTURE & PLACE	DRG CHECK	D.JOHNSON		NSW		ROADSII
						SCALE 1:1000m	ENGINEERING SERVICES	DESIGN	D. TIGHT		GOVERNMENT	for NSW	HW16 BRUX
1							ROAD DESIGN NORTHERN	DESIGN CHECK	D.JOHNSON		PREPARED FOR		TfNSW REGISTR
-						CO-ORDINATE SYSTEM HEIGHT DATUM	1	DESIGN MANAGER	D.JOHNSON		REGIONAL MAINT REGIONAL MAINT	ENANCE ENANCE DELIVERY NORTHERN	ISSUE STATUS
						MGA ZONE 56 AHD		PROJECT MANAGER	R. GERSERKOWS				DETAIL DES

COUNCIL BRUXNER HIGHWAY

ANGANEE RANGE - WILLOCK STREET S5390-5400 km TO 39.66km FROM CASINO SIDE FURNITURE PLAN

RUXNER HIGHWAY - MC00 - 37519 TO 37750 SISTRATION No. DS2020/000063

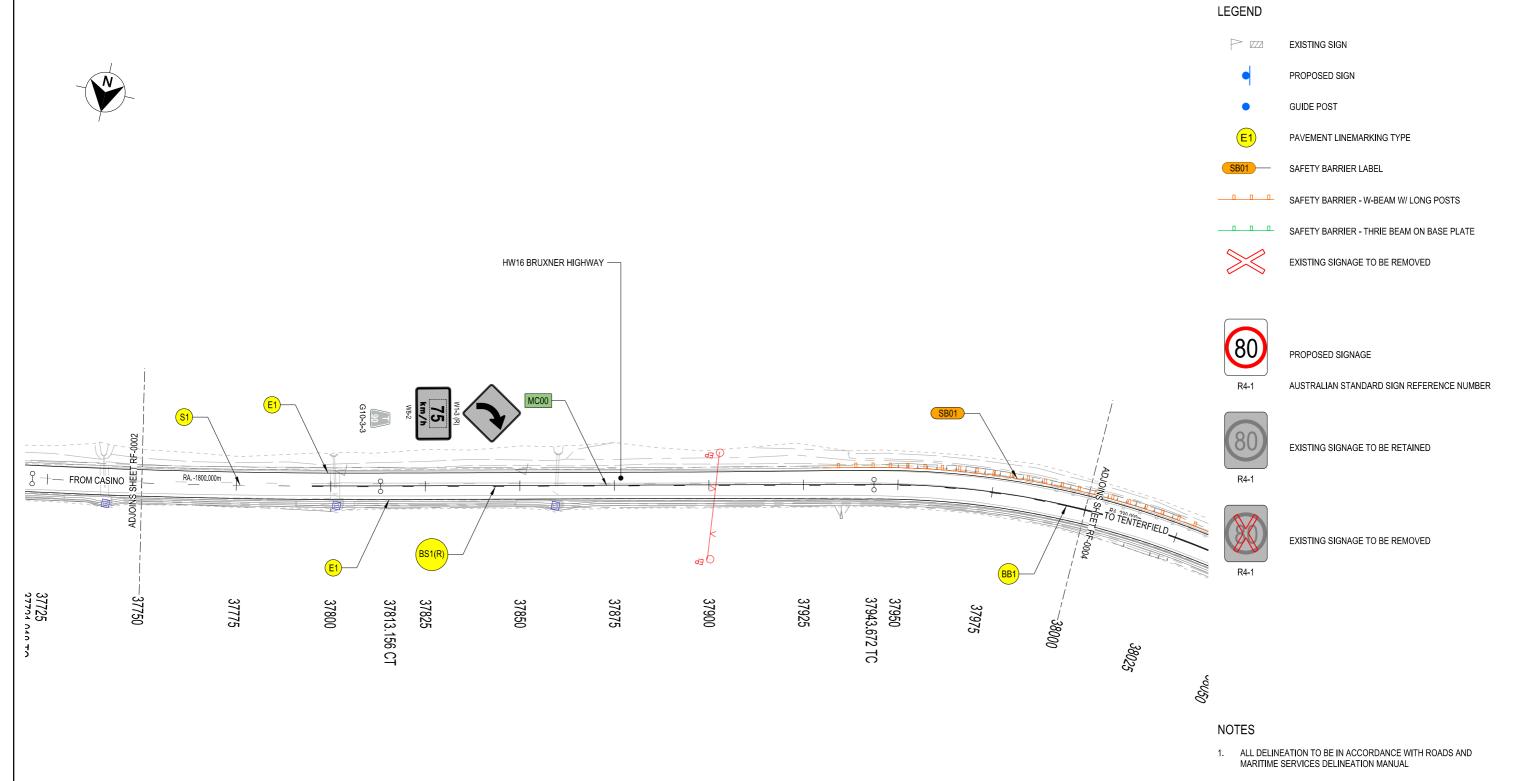

SIGN POSTING TO BE INSTALLED IN ACCORDANCE WITH ROADS AND MARITIME DOCUMENT "INSTALLATION AND MAINTENANCE OF SIGNS" AND AS1742

UTILITY INFORMATION SHOWN ON THE PLANS DOES NOT DEPICT ANY MORE THAN THE PRESENCE OF A SERVICE, BASED ON AVAILABLE DOCUMENTARY EVIDENCE. THE PRESENCE OF A UTILITY SERVICE, ITS SIZE AND LOCATION SHOULD BE CONFIRMED BY FIELD INSPECTION, PRIOR TO THE COMMENCEMENT OF ROADWORKS AND THE RELEVANT UTILITY PLANS OBTAINED BY DIALLING PH 1100 OR FAX 1300 652 077 (DIAL BEFORE YOU DIG). CAUTION SHOULD BE EXERCISED WHEN WORKING IN THE VICINITY OF ALL UTILITY SERVICES.

NOT FOR CONSTRUCTION


	DRAWING FILE LOCATION / NAME K:\PROJECTS\16_BRUXNER HIGHWAY\N2019070 Mallanganee Range a	ROJECTS(16_BRUXNER HIGHWAY)N2019070 Mallanganee Range and Willock st S5390_S5400IDRAWINGS)FinaliDS2020-000063-08-RF.dgn			DESIGN LOT CODE N2019070 DESIGN MODEL FILE(S) USED FOR DOCUMENTATION OF THIS HW16_MallanganeeRangeWillock_Design_IFC_V				PLOT DATE / TIME PLOT BY 11/07/2022 1:12:34 PM tightd		CLIENT		KYOGLE COUN HW16 - BRUXN
	EXTERNAL REFERENCE FILES	REV	DATE	AMENDMENT / REVISION DESCRIPTION	WVR No.	APPROVAL	SCALES ON A3 SIZE DRAWING	DRAWINGS / DESIGN PREPARED BY	TITLE	NAME		_	MALLANG
								TRANSPORT FOR NSW	DRAWN	D. TIGHT		Transport	37.52km T0
							0 10 20 30 40	INFRASTRUCTURE & PLACE	DRG CHECK	D.JOHNSON	NSW		ROADSIDE
,							SCALE 1:1000m	ENGINEERING SERVICES	DESIGN	D. TIGHT	GOVERNMENT	for NSW	HW16 BRUXNE
								ROAD DESIGN NORTHERN	DESIGN CHECK	D.JOHNSON	PREPARED FOR		TfNSW REGISTRATI
,							CO-ORDINATE SYSTEM HEIGHT DATUM	-	DESIGN MANAGER	D.JOHNSON	REGIONAL MAINTI	ENANCE ENANCE DELIVERY NORTHERN	ISSUE STATUS
,							MGA ZONE 56 AHD		PROJECT MANAGER	R. GERSERKOWSKI			DETAIL DESIG

COUNCIL

NGANEE RANGE - WILLOCK STREET S5390-5400 TO 39.66km FROM CASINO IDE FURNITURE PLAN

JXNER HIGHWAY - MC00 - 37750 TO 38000


DS2020/000063 RF-0003

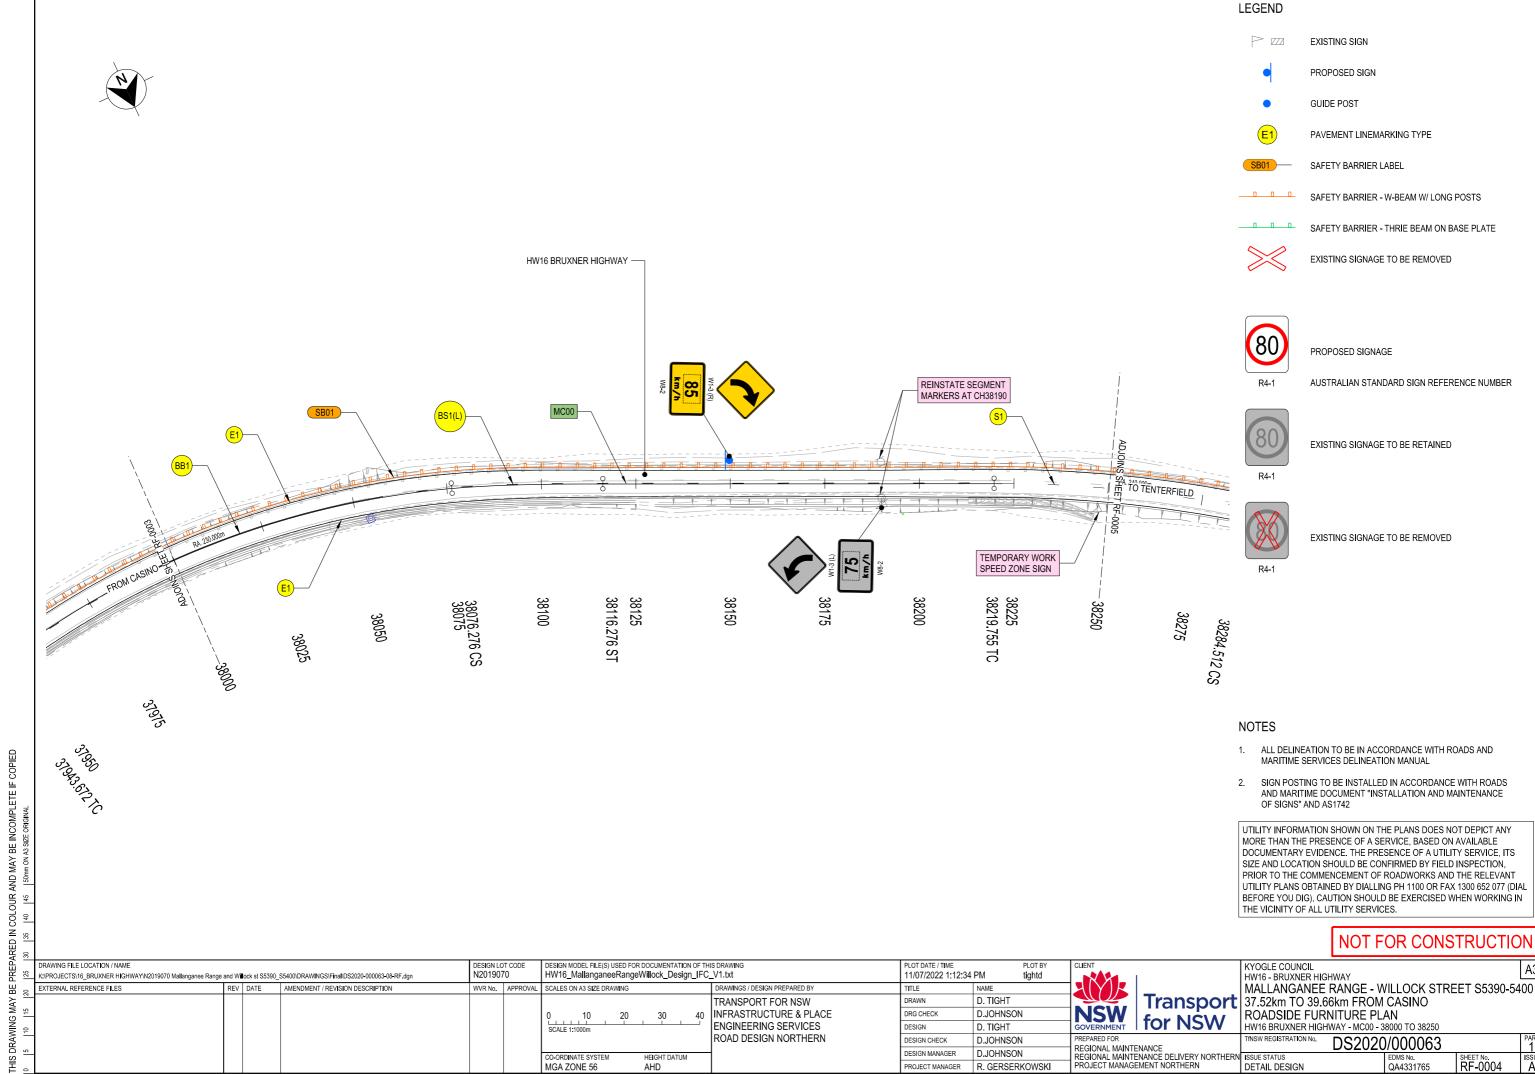

DOCUMENTARY EVIDENCE. THE PRESENCE OF A UTILITY SERVICE, ITS SIZE AND LOCATION SHOULD BE CONFIRMED BY FIELD INSPECTION, PRIOR TO THE COMMENCEMENT OF ROADWORKS AND THE RELEVANT UTILITY PLANS OBTAINED BY DIALLING PH 1100 OR FAX 1300 652 077 (DIAL BEFORE YOU DIG). CAUTION SHOULD BE EXERCISED WHEN WORKING IN THE VICINITY OF ALL UTILITY SERVICES.

NOT FOR CONSTRUCTION

જ						THE FIT STATE OF THE STATE OF T	.,,,,
_	DRAWING FILE LOCATION / NAME		D FOR DOCUMENTATION OF THIS DRAWING	PLOT DATE / TIME PLOT BY	CLIENT	KYOGLE COUNCIL	A3
Ϋ́	K:\PROJECTS\16_BRUXNER HIGHWAY\N2019070 Mallanganee Range and W∎ock st S5390_S5400\DRAWINGS\FinaIDS2020-000063-08-	dgn N2019070 HW16_MallanganeeRa	angeWillock_Design_IFC_V1.txt	11/07/2022 1:12:34 PM tightd		HW16 - BRUXNER HIGHWAY	
2.	EXTERNAL REFERENCE FILES REV DATE AMENDMENT / REVISION DESCRIPTION	WVR No. APPROVAL SCALES ON A3 SIZE DRAWIN	NG DRAWINGS / DESIGN PREPARED BY	TITLE NAME		MALLANGANEE RANGE - WILLOCK STREET S539	<i>3</i> 0-5400
•			TRANSPORT FOR NSW	D. TIGHT	Transport	37.52km TO 39.66km FROM CASINO	
2		0 10 2	20 30 40 INFRASTRUCTURE & PLACE	DRG CHECK D.JOHNSON		ROADSIDE FURNITURE PLAN	
2		SCALE 1:1000m	ENGINEERING SERVICES	DESIGN D. TIGHT	GOVERNMENT for NSW	HW16 BRUXNER HIGHWAY - MC00 - 38000 TO 38250	
			ROAD DESIGN NORTHERN	DESIGN CHECK D.JOHNSON	PREPARED FOR	Trinsw registration no. DS2020/000063	PART 1
2		CO-ORDINATE SYSTEM	HEIGHT DATUM	D.JOHNSON	REGIONAL MAINTENANCE REGIONAL MAINTENANCE DELIVERY NORTHERN		ISSUE
>		MGA ZONE 56	AHD	PROJECT MANAGER R. GERSERKOWSKI	PROJECT MANAGEMENT NORTHERN	DETAIL DESIGN QA4331765 RF-0004	4 Å
						6 T	and fam NIC\AI

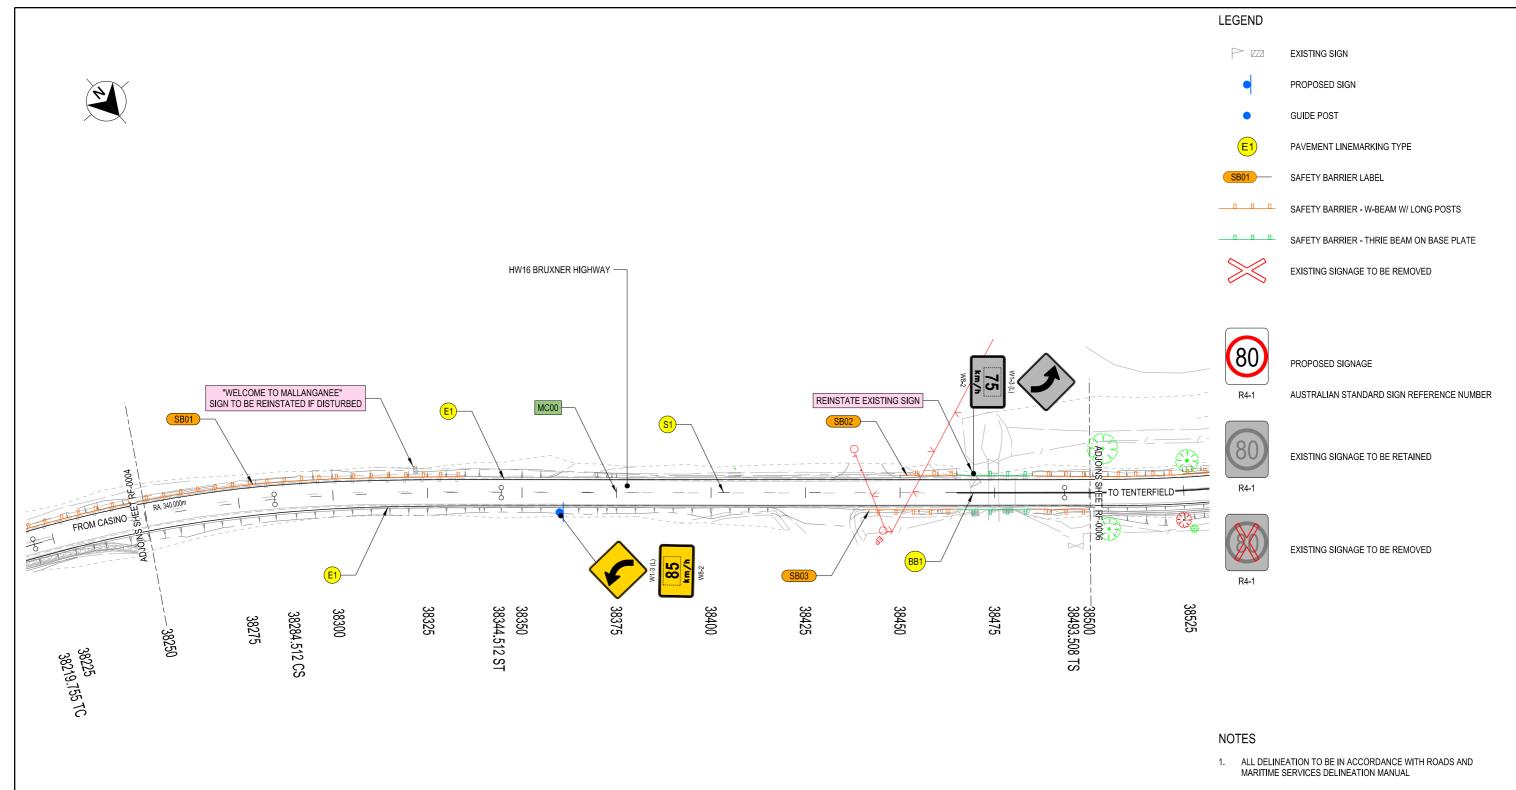


SIGN POSTING TO BE INSTALLED IN ACCORDANCE WITH ROADS AND MARITIME DOCUMENT "INSTALLATION AND MAINTENANCE OF SIGNS" AND AS1742

UTILITY INFORMATION SHOWN ON THE PLANS DOES NOT DEPICT ANY MORE THAN THE PRESENCE OF A SERVICE, BASED ON AVAILABLE DOCUMENTARY EVIDENCE. THE PRESENCE OF A UTILITY SERVICE, ITS SIZE AND LOCATION SHOULD BE CONFIRMED BY FIELD INSPECTION, PRIOR TO THE COMMENCEMENT OF ROADWORKS AND THE RELEVANT UTILITY PLANS OBTAINED BY DIALLING PH 1100 OR FAX 1300 652 077 (DIAL BEFORE YOU DIG). CAUTION SHOULD BE EXERCISED WHEN WORKING IN THE VICINITY OF ALL UTILITY SERVICES.

NOT FOR CONSTRUCTION

3													NOT FOR CONS	STRUCTIO	N
. I	DRAWING FILE LOCATION / NAME K:PROJECTS\16_BRUXNER HIGHWAYIN2019070 Mallanganee Range and Wil	lock st S5390_	S5400\DRAWINGS\Final\DS2020-000063-08-RF.dgn	DESIGN LOT CODE N2019070	DESIGN MODEL FILE(S) USED F HW16_MallanganeeRan			PLOT DATE / TIME 11/07/2022 1:12:3	PLOT BY 5 PM tightd	CLIENT		KYOGLE COUNCIL HW16 - BRUXNER HIGH			А3
₃ [EXTERNAL REFERENCE FILES REV	DATE	AMENDMENT / REVISION DESCRIPTION	WVR No. APPRO	IVAL SCALES ON A3 SIZE DRAWING		DRAWINGS / DESIGN PREPARED BY	TITLE	NAME				RANGE - WILLOCK STR	REET S5390-540	00
Ť							TRANSPORT FOR NSW	DRAWN	D. TIGHT		Transport	37.52km TO 39.66	6km FROM CASINO		
2					0 10 20	30 40	INFRASTRUCTURE & PLACE	DRG CHECK	D.JOHNSON	NSW GOVERNMENT		ROADSIDE FURN	NITURE PLAN		
ا ₂					SCALE 1:1000m		ENGINEERING SERVICES	DESIGN	D. TIGHT	GOVERNMENT	for NSW		WAY - MC00 - 38250 TO 38500		
┪							ROAD DESIGN NORTHERN	DESIGN CHECK	D.JOHNSON	PREPARED FOR		TfNSW REGISTRATION No.	DS2020/000063		PART
<u>, </u>					CO-ORDINATE SYSTEM	HEIGHT DATUM	1	DESIGN MANAGER	D.JOHNSON	REGIONAL MAINT	ENANCE ENANCE DEL I VERY NORTHERN		EDMS No.	SHEET No.	ISSUE
,					MGA ZONE 56	AHD		PROJECT MANAGER	R. GERSERKOWSKI			DETAIL DESIGN	QA4331765	RF-0005	Α

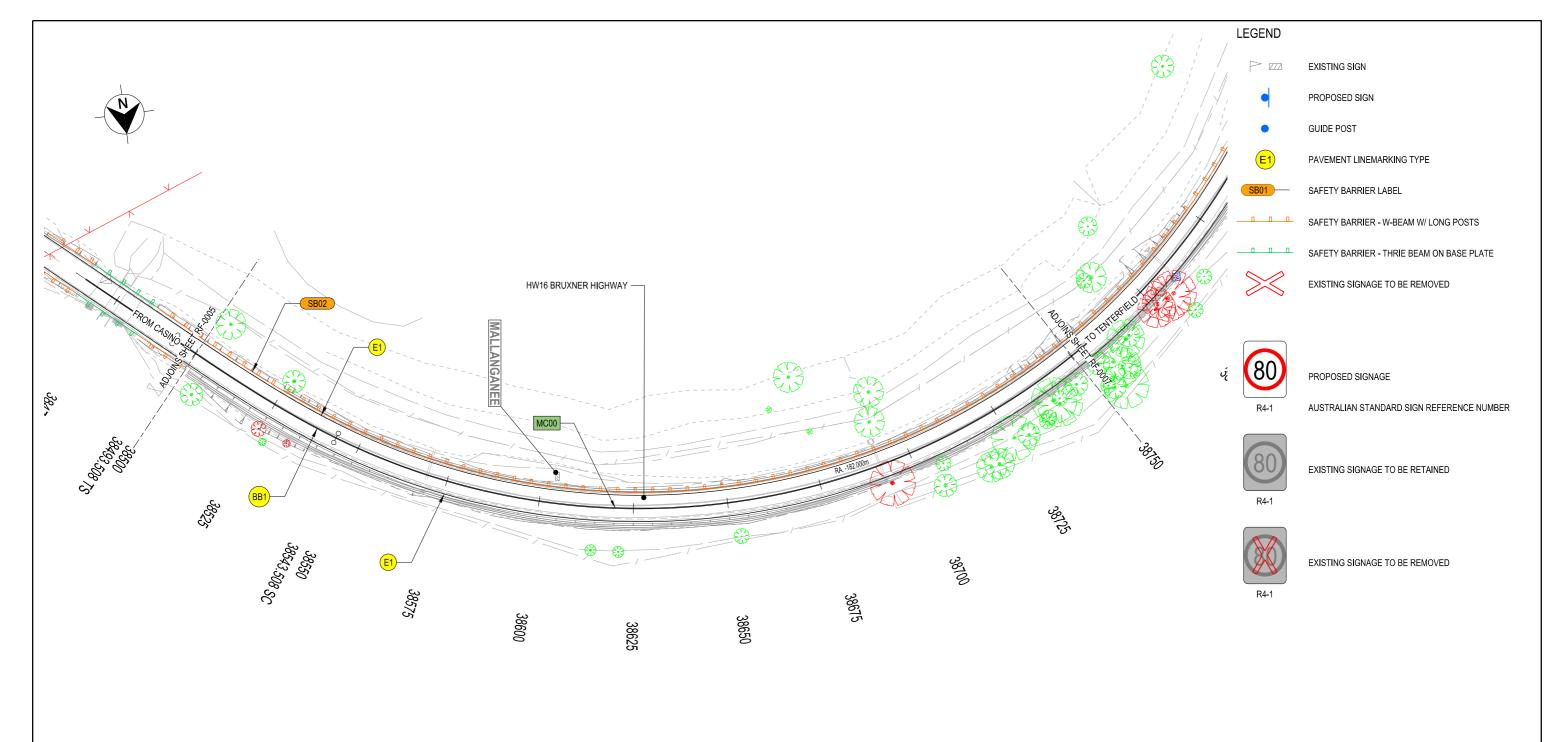

NOTES

- ALL DELINEATION TO BE IN ACCORDANCE WITH ROADS AND MARITIME SERVICES DELINEATION MANUAL
- SIGN POSTING TO BE INSTALLED IN ACCORDANCE WITH ROADS AND MARITIME DOCUMENT "INSTALLATION AND MAINTENANCE OF SIGNS" AND AS1742

UTILITY INFORMATION SHOWN ON THE PLANS DOES NOT DEPICT ANY MORE THAN THE PRESENCE OF A SERVICE, BASED ON AVAILABLE DOCUMENTARY EVIDENCE. THE PRESENCE OF A UTILITY SERVICE, ITS SIZE AND LOCATION SHOULD BE CONFIRMED BY FIELD INSPECTION, PRIOR TO THE COMMENCEMENT OF ROADWORKS AND THE RELEVANT UTILITY PLANS OBTAINED BY DIALLING PH 1100 OR FAX 1300 652 077 (DIAL BEFORE YOU DIG). CAUTION SHOULD BE EXERCISED WHEN WORKING IN THE VICINITY OF ALL UTILITY SERVICES.


NOT FOR CONSTRUCTION


DRAWING FILE LOCATION / NAME K:PROJECTS\16_BRUXNER HIGHWAY\N2019070 Mallanganee Range and W 1 ock st S5390_S54	I	DESIGN LOT N2019070		DESIGN MODEL FILE(S) USED FOR DOCUMENTATION OF THE HW16_MallanganeeRangeWillock_Design_IFC		PLOT DATE / TIME 11/07/2022 1:12:38	PLOT BY 5 PM tightd	CLIENT		KYOGLE CO
EXTERNAL REFERENCE FILES REV DATE A	AMENDMENT / REVISION DESCRIPTION	WVR No.	APPROVAL	SCALES ON A3 SIZE DRAWING	DRAWINGS / DESIGN PREPARED BY	TITLE	NAME			MALLAN
					TRANSPORT FOR NSW	DRAWN	D. TIGHT		Transport	37.52km
1				0 10 20 30 40	INFRASTRUCTURE & PLACE	DRG CHECK	D.JOHNSON	\square NSW		ROADSII
				SCALE 1:1000m	ENGINEERING SERVICES	DESIGN	D. TIGHT	GOVERNMENT		HW16 BRUX
1					ROAD DESIGN NORTHERN	DESIGN CHECK	D.JOHNSON	PREPARED FOR		TfNSW REGISTE
-				CO-ORDINATE SYSTEM HEIGHT DATUM	1	DESIGN MANAGER	D.JOHNSON	REGIONAL MAIN	TENANCE TENANCE DEL I VERY NORTHERN	ISSUE STATUS
				MGA ZONE 56 AHD		PROJECT MANAGER	R. GERSERKOWSKI			DETAIL DES

COUNCIL BRUXNER HIGHWAY

ANGANEE RANGE - WILLOCK STREET S5390-5400 km TO 39.66km FROM CASINO

DSIDE FURNITURE PLAN BRUXNER HIGHWAY - MC00 - 38500 TO 38750 DS2020/000063

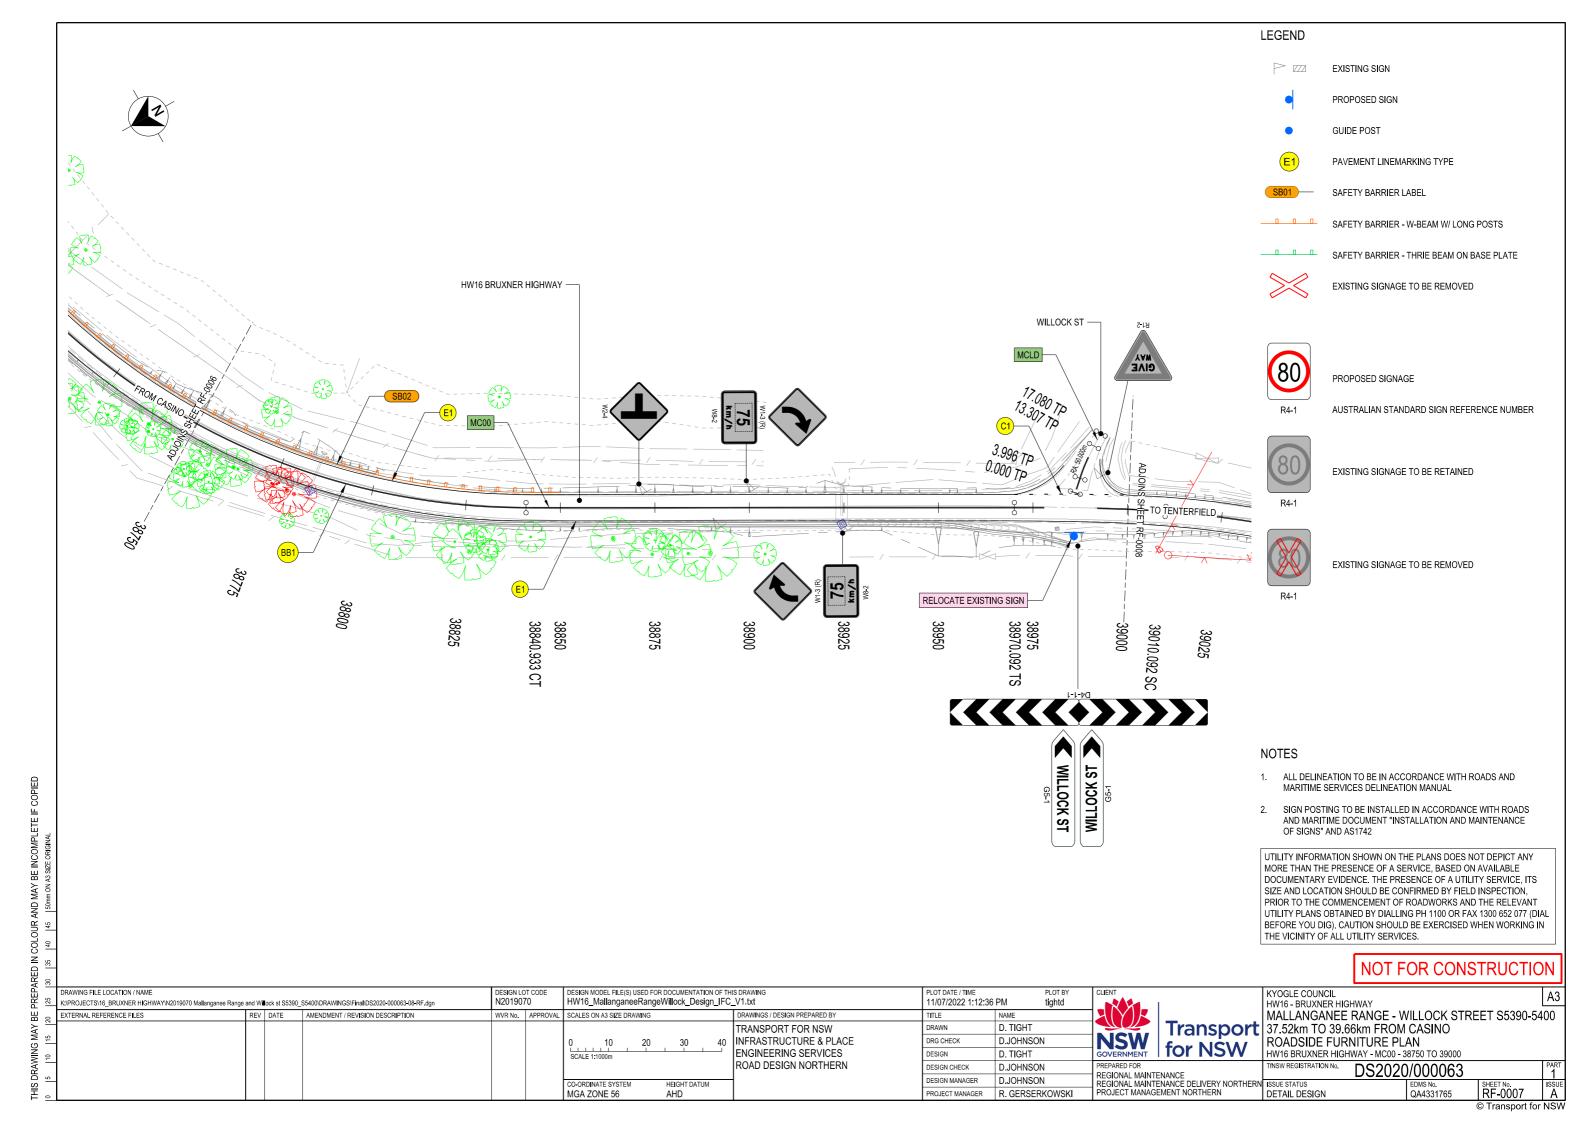

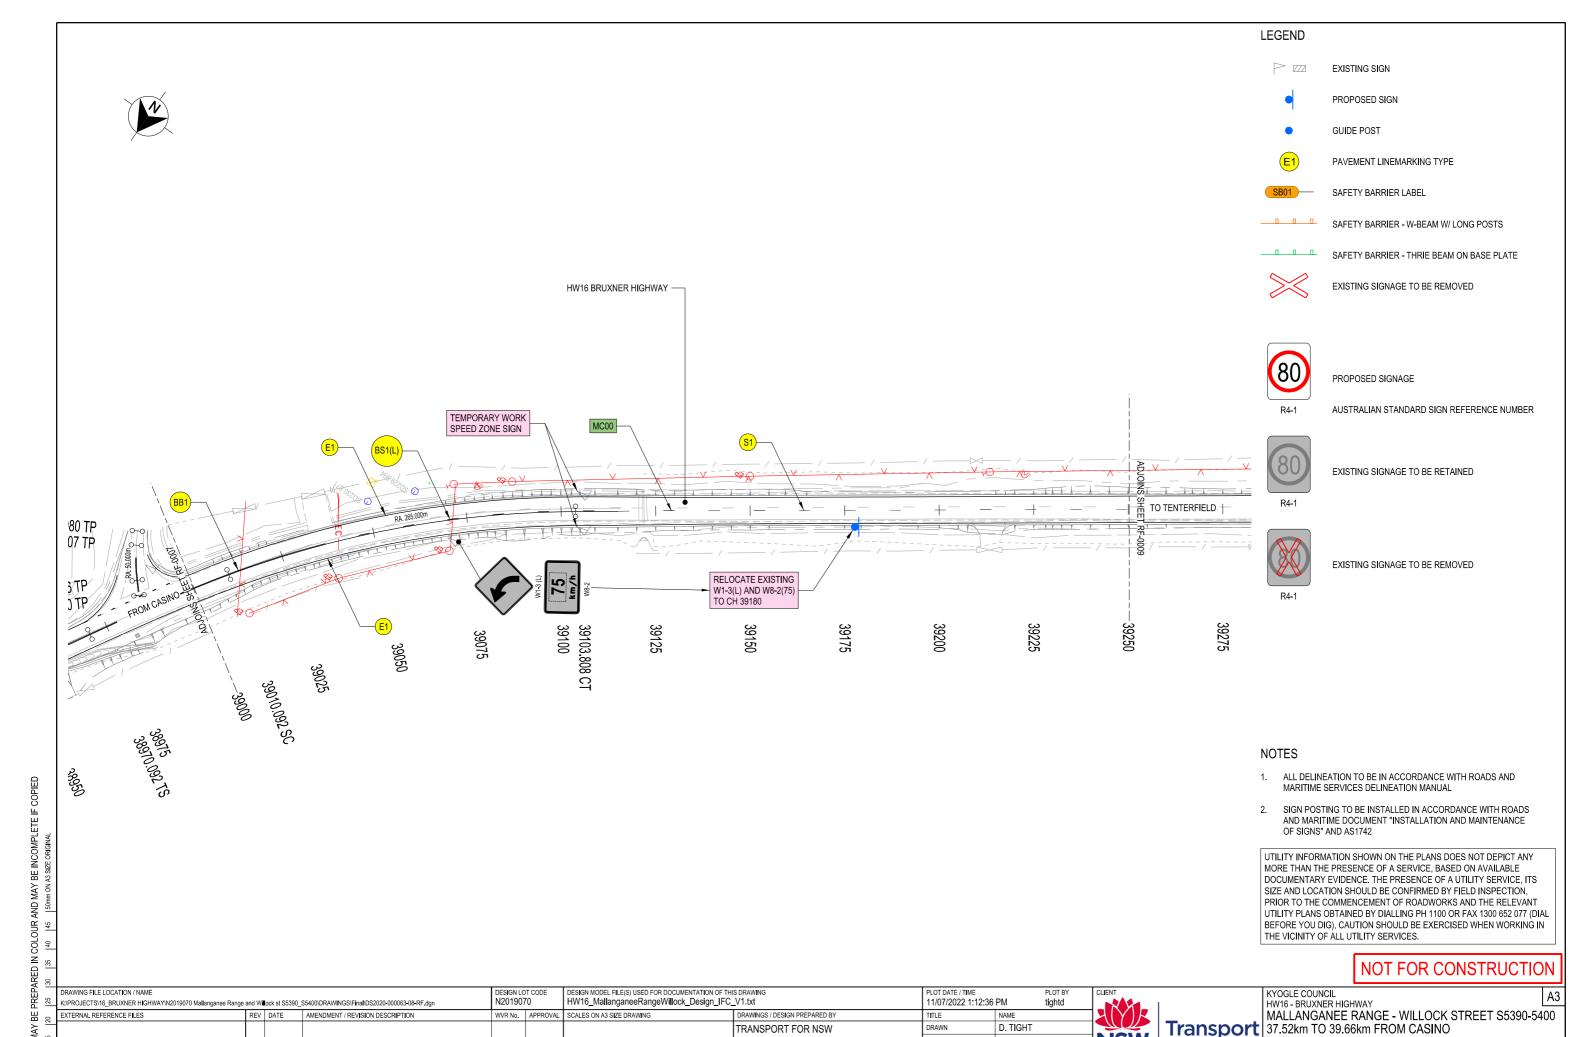

INFRASTRUCTURE & PLACE

ENGINEERING SERVICES

ROAD DESIGN NORTHERN

30

HEIGHT DATUM

MGA ZONE 56

ORG CHECK

DESIGN MANAGER

DESIGN

D.JOHNSON

D.JOHNSON

D.JOHNSON

D. TIGHT

PROJECT MANAGER R. GERSERKOWSKI

RF-0008 A

ROADSIDE FURNITURE PLAN


TfNSW REGISTRATION No.

HW16 BRUXNER HIGHWAY - MC00 - 39000 TO 39250

DS2020/000063

for NSW

REGIONAL MAINTENANCE
REGIONAL MAINTENANCE DELIVERY NORTHERN ISSUE STATUS
PROJECT MANAGEMENT NORTHERN DETAIL DES

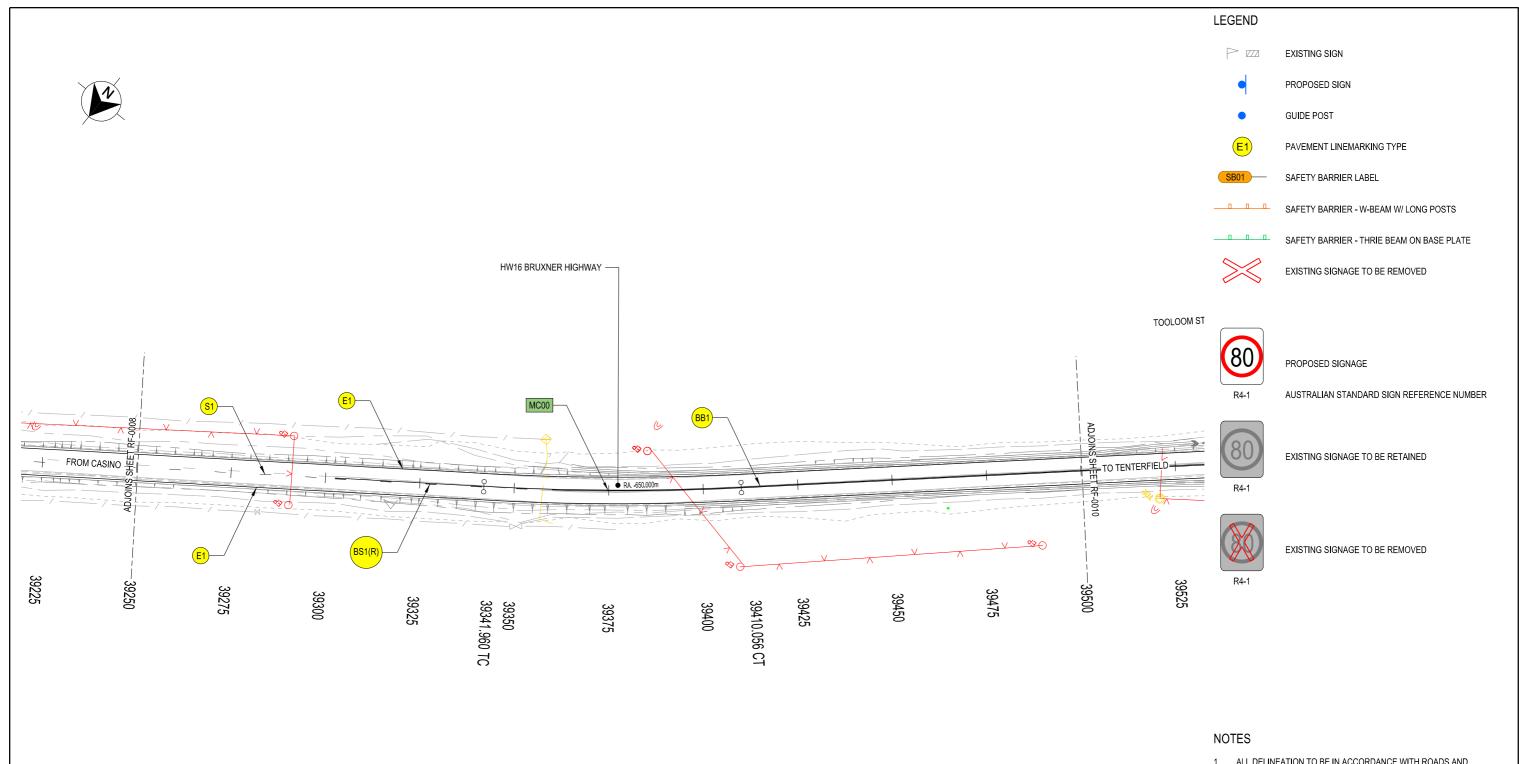

- . ALL DELINEATION TO BE IN ACCORDANCE WITH ROADS AND MARITIME SERVICES DELINEATION MANUAL
- SIGN POSTING TO BE INSTALLED IN ACCORDANCE WITH ROADS AND MARITIME DOCUMENT "INSTALLATION AND MAINTENANCE OF SIGNS" AND AS1742

UTILITY INFORMATION SHOWN ON THE PLANS DOES NOT DEPICT ANY MORE THAN THE PRESENCE OF A SERVICE, BASED ON AVAILABLE DOCUMENTARY EVIDENCE. THE PRESENCE OF A UTILITY SERVICE, ITS SIZE AND LOCATION SHOULD BE CONFIRMED BY FIELD INSPECTION, PRIOR TO THE COMMENCEMENT OF ROADWORKS AND THE RELEVANT UTILITY PLANS OBTAINED BY DIALLING PH 1100 OR FAX 1300 652 077 (DIAL BEFORE YOU DIG). CAUTION SHOULD BE EXERCISED WHEN WORKING IN THE VICINITY OF ALL UTILITY SERVICES.

NOT FOR CONSTRUCTION

DRAWING FILE LOCATION / NAME K:PROJECTS\16_BRUXNER HIGHWAY\N2019070 Mallanganee Range	OJECTS\16_BRUXNER HIGHWAY\N2019070 Mallanganee Range and Willock st S5390_S5400\DRAWINGS\Final\DS2020-000063-08-RF.dgn				DESIGN MODEL FILE(S) USED FOR DOCUMENTATION OF THE HW16_MallanganeeRangeWillock_Design_IFC		PLOT DATE / TIME 11/07/2022 1:12:3	PLOT BY 7 PM tightd	CLIENT	KYOGLE COUN HW16 - BRUXN
EXTERNAL REFERENCE FILES	REV DATE	AMENDMENT / REVISION DESCRIPTION	WVR No.	APPROVAL	SCALES ON A3 SIZE DRAWING	DRAWINGS / DESIGN PREPARED BY	TITLE	NAME		MALLANGA
1						TRANSPORT FOR NSW	DRAWN	D. TIGHT	Transport	37.52km TC
					0 10 20 30 40	INFRASTRUCTURE & PLACE	DRG CHECK	D.JOHNSON		ROADSIDE
					SCALE 1:1000m	ENGINEERING SERVICES	DESIGN	D. TIGHT	GOVERNMENT for NSW	HW16 BRUXNE
1						ROAD DESIGN NORTHERN	DESIGN CHECK	D.JOHNSON	PREPARED FOR	TfNSW REGISTRATIO
4					CO-ORDINATE SYSTEM HEIGHT DATUM	-	DESIGN MANAGER	D.JOHNSON	REGIONAL MAINTENANCE REGIONAL MAINTENANCE DELIVERY NORTHERN	I ISSUE STATUS
					MGA ZONE 56 AHD		PROJECT MANAGER	R. GERSERKOWSKI		DETAIL DESIGN


GLE COUNCIL
6. BRITANER HIGHWAY

MALLANGANEE RANGE - WILLOCK STREET S5390-5400 37.52km TO 39.66km FROM CASINO ROADSIDE FURNITURE PLAN

HW16 BRUXNER HIGHWAY - MC00 - 39250 TO 39500

RATION NO. DS2020/000063 PAR 1 SHEET NO. ISSUE NO. RF-0009 A 24331765 RF-0009

ransport for N

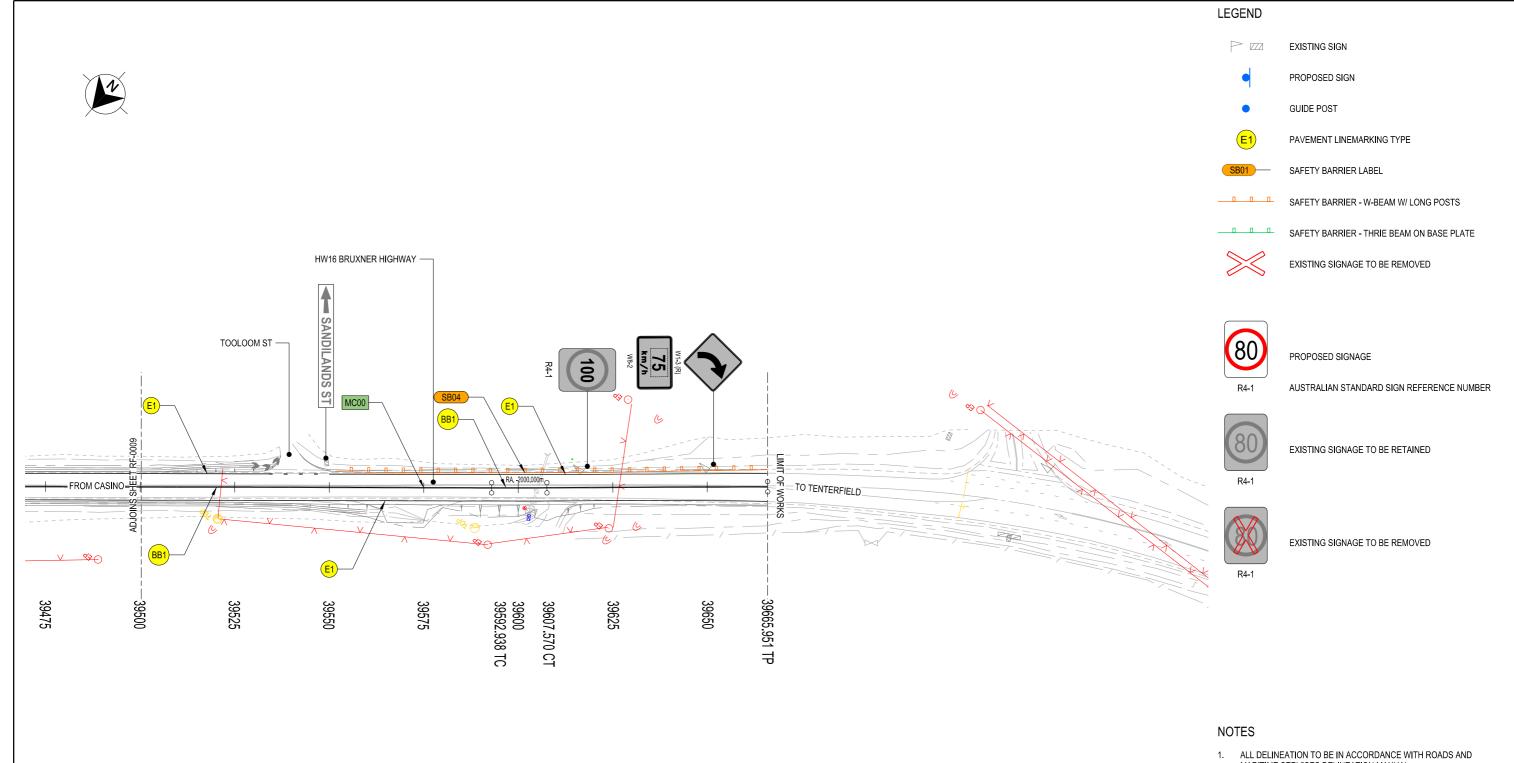

- ALL DELINEATION TO BE IN ACCORDANCE WITH ROADS AND MARITIME SERVICES DELINEATION MANUAL
- SIGN POSTING TO BE INSTALLED IN ACCORDANCE WITH ROADS AND MARITIME DOCUMENT "INSTALLATION AND MAINTENANCE OF SIGNS" AND AS1742

UTILITY INFORMATION SHOWN ON THE PLANS DOES NOT DEPICT ANY MORE THAN THE PRESENCE OF A SERVICE, BASED ON AVAILABLE DOCUMENTARY EVIDENCE. THE PRESENCE OF A UTILITY SERVICE, ITS SIZE AND LOCATION SHOULD BE CONFIRMED BY FIELD INSPECTION, PRIOR TO THE COMMENCEMENT OF ROADWORKS AND THE RELEVANT UTILITY PLANS OBTAINED BY DIALLING PH 1100 OR FAX 1300 652 077 (DIAL BEFORE YOU DIG). CAUTION SHOULD BE EXERCISED WHEN WORKING IN THE VICINITY OF ALL UTILITY SERVICES.

NOT FOR CONSTRUCTION

]											NOT FOR CON	STRUCTION	╝
DRAWING FILE LOCATION / NAME K:\PROJECTS\16_BRUXNER HIGHWAY\N2019	9070 Mallanganee Range and W ∎ ock st S539	0_S5400\DRAWINGS\Final\DS2020-000063-08-RF.dgn	DESIGN LOT CODE N2019070	DESIGN MODEL FILE(S) USED FOR DOCUMENTATION OF THE HW16_MallanganeeRangeWillock_Design_IFC		PLOT DATE / TIME 11/07/2022 1:12:37	PLOT BY 7 PM tightd	CLIENT		KYOGLE COUNCIL HW16 - BRUXNER HIGH	HWAY	А	3
EXTERNAL REFERENCE FILES	REV DATE	AMENDMENT / REVISION DESCRIPTION	WVR No. APPROVAL	SCALES ON A3 SIZE DRAWING	DRAWINGS / DESIGN PREPARED BY	TITLE	NAME	AIYIR		MALLANGANEE	RANGE - WILLOCK STF	REET S5390-5400	.
1					TRANSPORT FOR NSW	DRAWN	D. TIGHT		Transport	37.52km TO 39.66	6km FROM CASINO		
4				0 10 20 30 40	INFRASTRUCTURE & PLACE	DRG CHECK	D.JOHNSON	NSW		ROADSIDE FURN	NITURE PLAN		
				SCALE 1:1000m	ENGINEERING SERVICES	DESIGN	D. TIGHT	GOVERNMENT	for NSW	HW16 BRUXNER HIGH	WAY - MC00 - 39500 TO 39656		
1					ROAD DESIGN NORTHERN	DESIGN CHECK	D.JOHNSON	PREPARED FOR	ENANCE.	TfNSW REGISTRATION No.	DS2020/000063	PA	₹Т
4				CO-ORDINATE SYSTEM HEIGHT DATUM	-	DESIGN MANAGER	D.JOHNSON	REGIONAL MAINT REGIONAL MAINT	ENANCE ENANCE DEL I VERY NORTHERN		EDMS No.	SHEET No. ISS	UE
				MGA ZONE 56 AHD		PROJECT MANAGER	R. GERSERKOWSKI			DETAIL DESIGN	QA4331765	RF-0010 A	1